CITY OF NEW LONDON OCEAN AVENUE ROADWAY RECONSTRUCTION FROM NILES HILL ROAD TO NEPTUNE AVENUE SEPTEMBER 2, 2016

REVISED: FEBRUARY 6, 2017

PROJECT FUNDED THROUGH THE CONNECTICUT DEPARTMENT OF TRANSPORTATION LOCAL TRANSPORTATION CAPITOL IMPROVEMENT PROGRAM (LOTCIP) STATE PROJECT No. L094-0001

THAMES SI DART SIE STARMINGTON AVE. PLANT VE	THE LA
	MARCA TER.
E NOB	WASON PL #1
P O RD.	WESTONETE FER.
MANSFIELD EASTRIDGE RD.	
TO GARDNER KE GARDNER PENNY IA HE	
RD. DEFCH_DR.	BOULDING CHAPEL ME
NILES PILL DE SE	CIENWOOD RE
ARTHUR ARTHUR DR.	
MAGINNIS OF Y. AITCHISON RD. WASH	WE REST.
IS NOODLAWN TO RD. PL. WORTH	DERSON RO.
COZY HILLSID	
BNSHORE BNSHORE F	Contract Brooks
GLENWOOD ROAD	PEQUOT
WOODBINE ST. RESULTING PAYE. HIGHLAND PAYE. ST.	APPROXIMATE LIMITS OF
RD. BIRCH PENINSULAR PENINSULAR NEP-TUNE AV	E. OTHER
REAT SOUTH AVE.	AVE. S
	Long Rock
Berch	1000 500 0
	GRAPHIC SCALE IN

CITY OF NEW LONDON, CONNECTICUT DEPARTMENT OF PUBLIC WORKS



QUALITY CONTROL CERTIFICATION

DRAWING INDEX

SHEET TITLE

COVER SHEET PLAN AND PROFILE

STATION 0+00 TO STATION 5+00

PLAN AND PROFILE

STATION 5+00 TO STATION 10+00 PLAN AND PROFILE

STATION 10+00 TO STATION 15+00 PLAN AND PROFILE

STATION 15+00 TO STATION 20+00 PLAN AND PROFILE

STATION 20+00 TO STATION 25+00 PLAN AND PROFILE

STATION 25+00 TO STATION 30+00 PLAN AND PROFILE

STATION 30+00 TO STATION 35+00 PLAN AND PROFILE

STATION 35+00 TO STATION 40+00 PLAN AND PROFILE

STATION 40+00 TO STATION 45+00

CONSTRUCTION DETAILS

CONSTRUCTION DETAILS

SHEET NUMBER

2

3

4

5

6

7

8

9

10

11

12

PROJECT MANAGER

ENVIRONMENTAL

STRUCTURAL ARCHITECTURAL



CME ASSOCIATES, INC.


SCALE: 1'=1000'


32 Crabtree Lane, Woodstock, CT 06281 333 East River Drive, East Hartford, CT 06108 50 Elm Street, Southbridge, MA 01550 888-291-3227 | www.cmeengineering.com


FEBRUARY 6, 2017 THIS BOUND SET OF PLANS WAS PRINTED


AND RELEASED ON THE ABOVE NOTED DATE


CME PROJECT #2016056

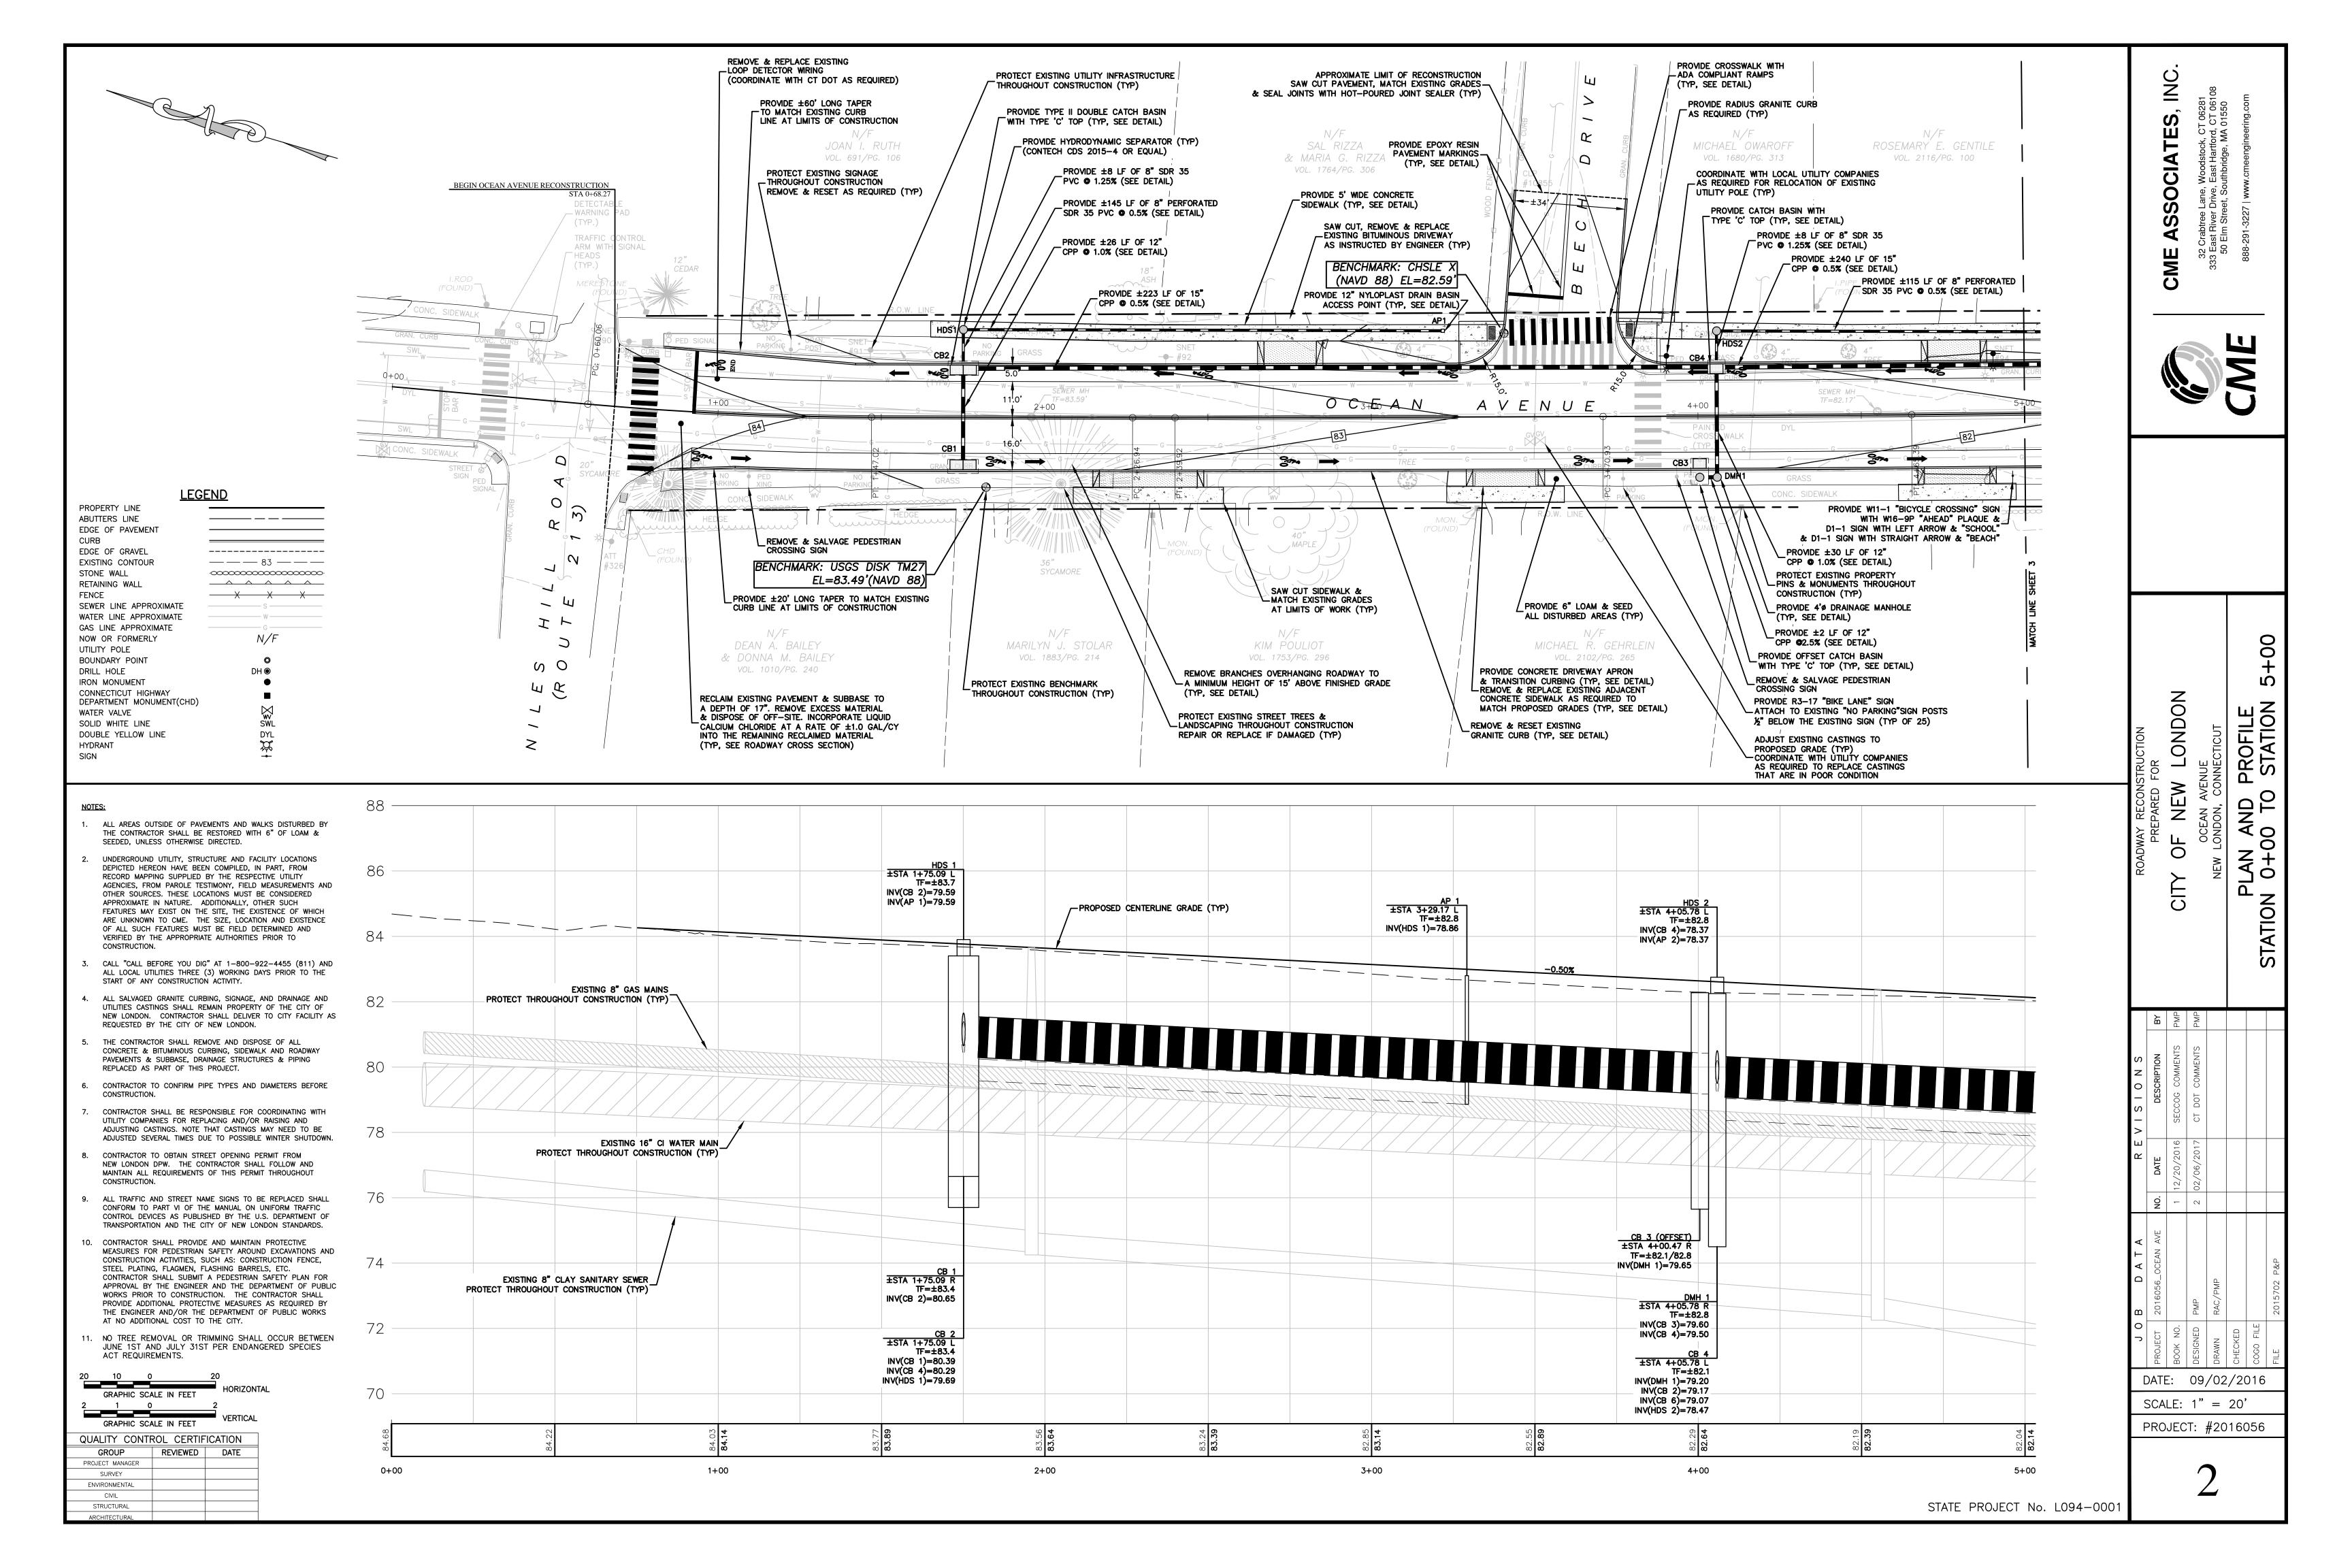


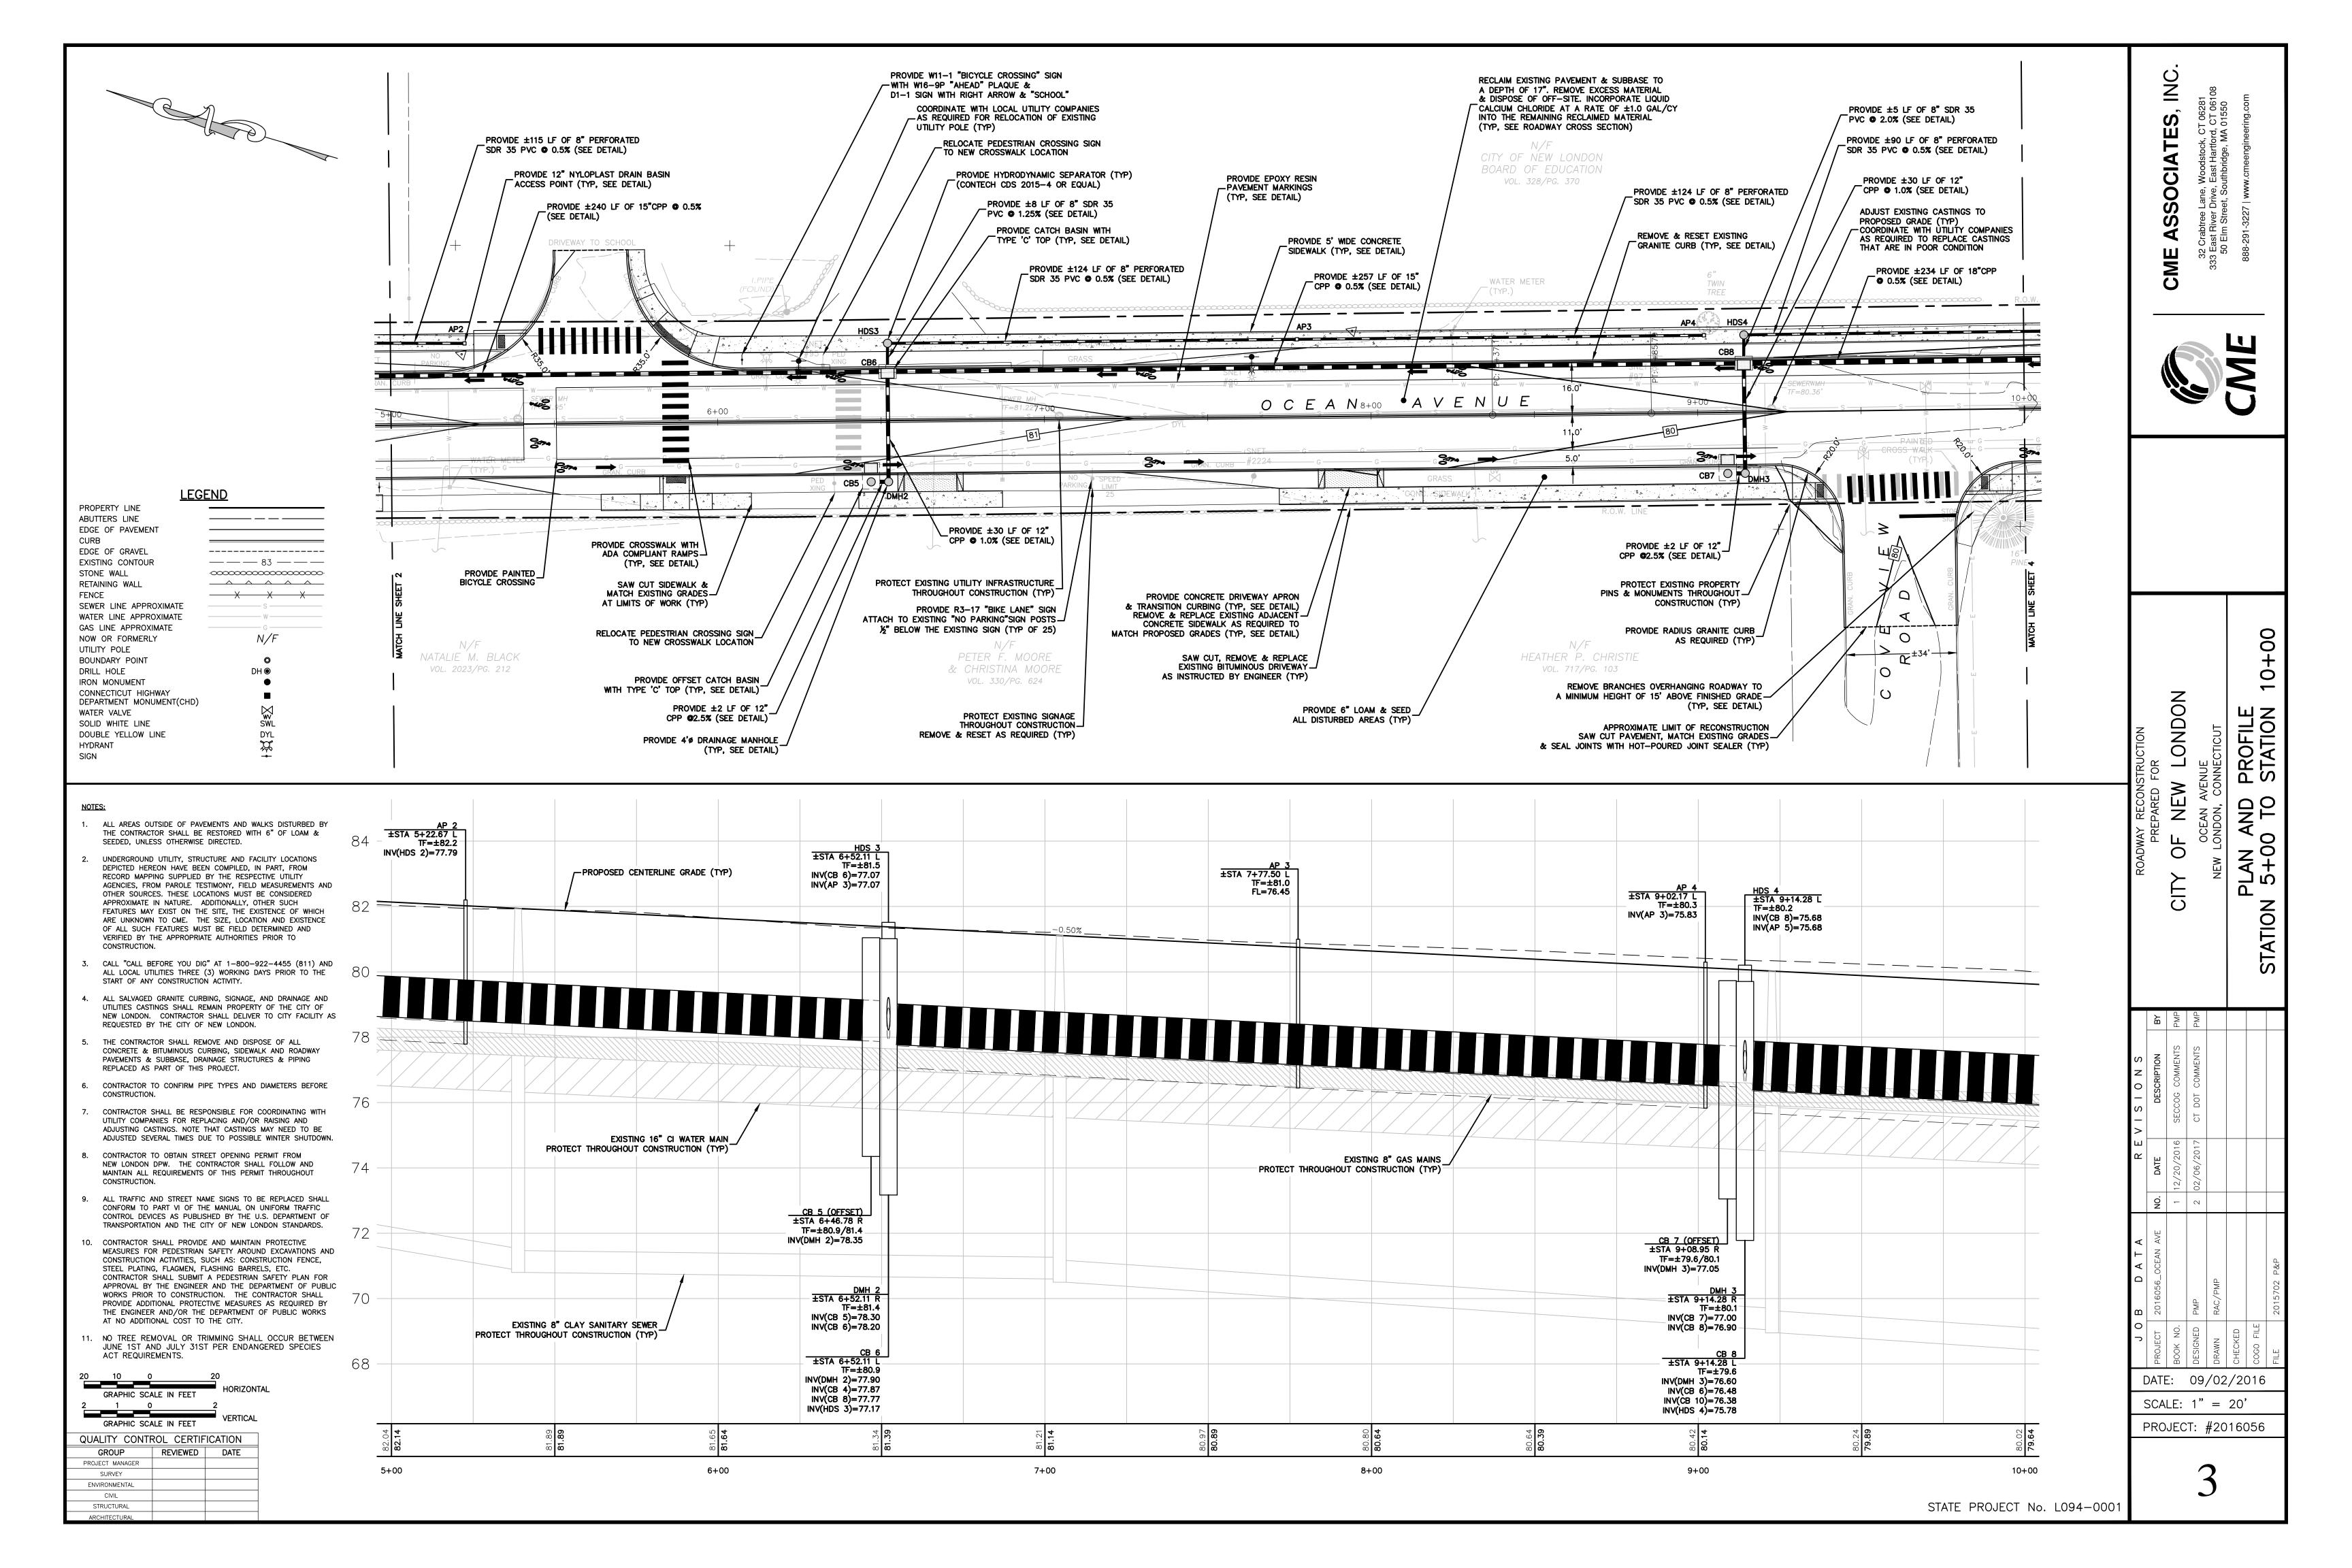


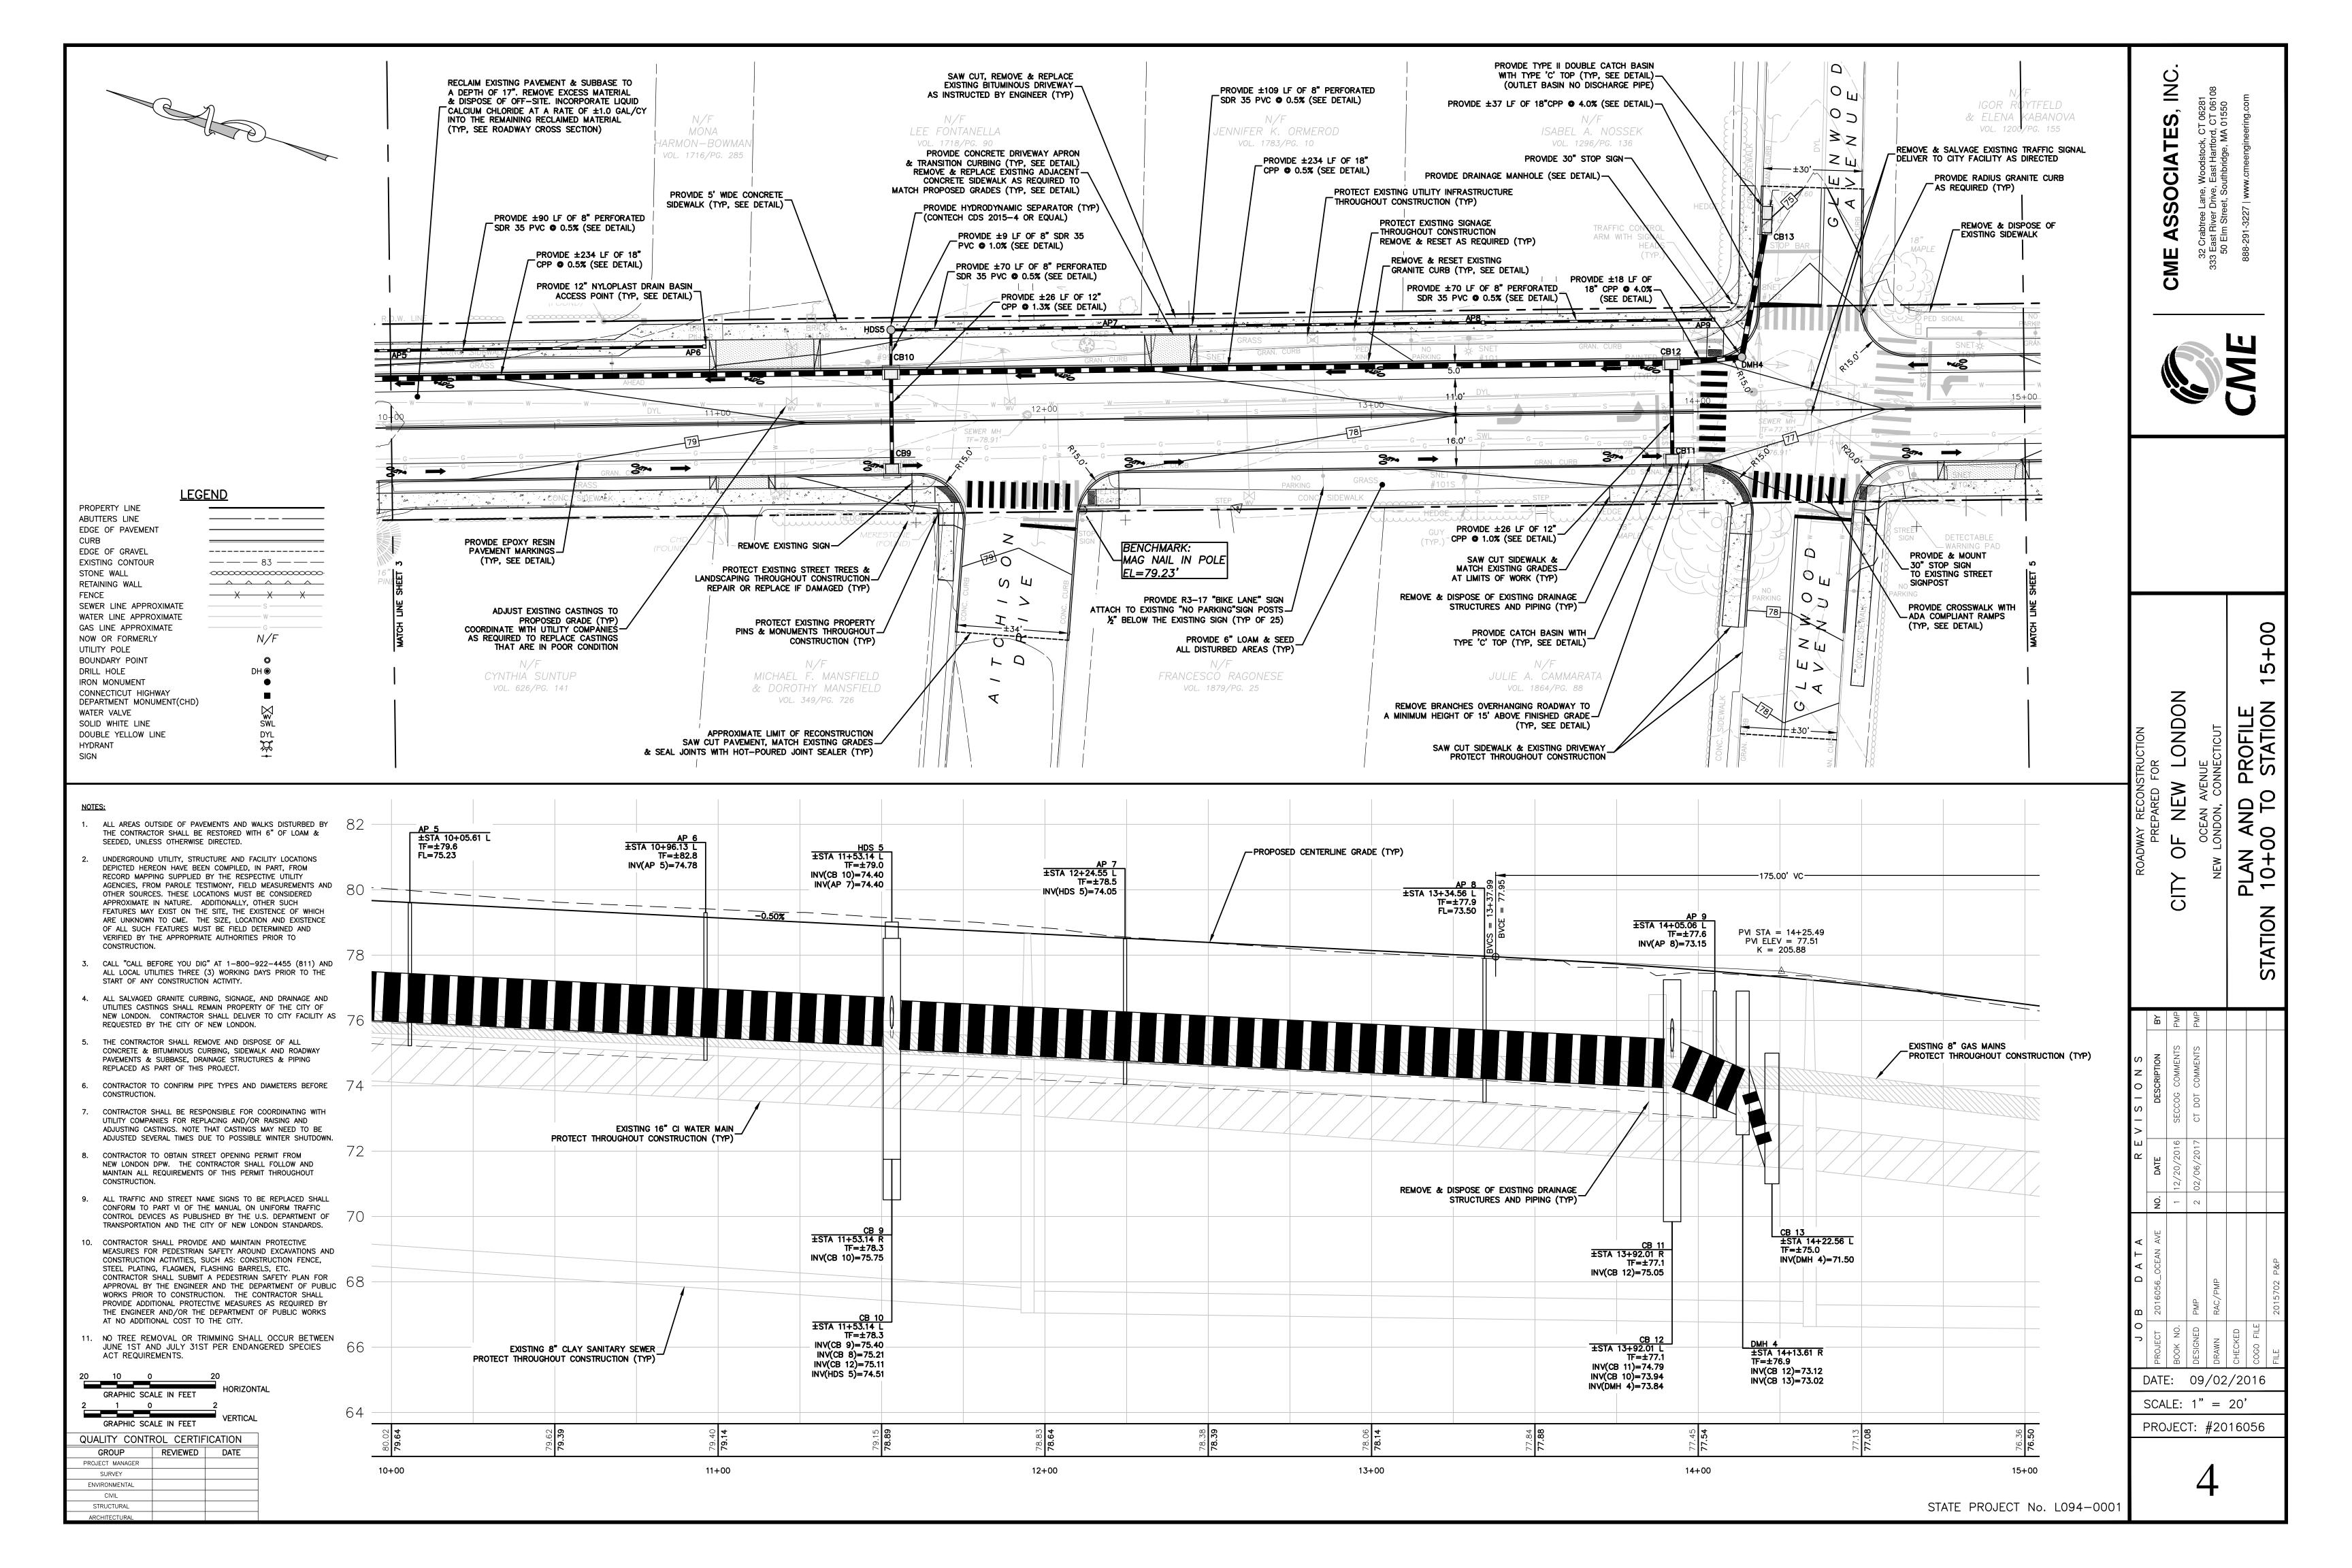


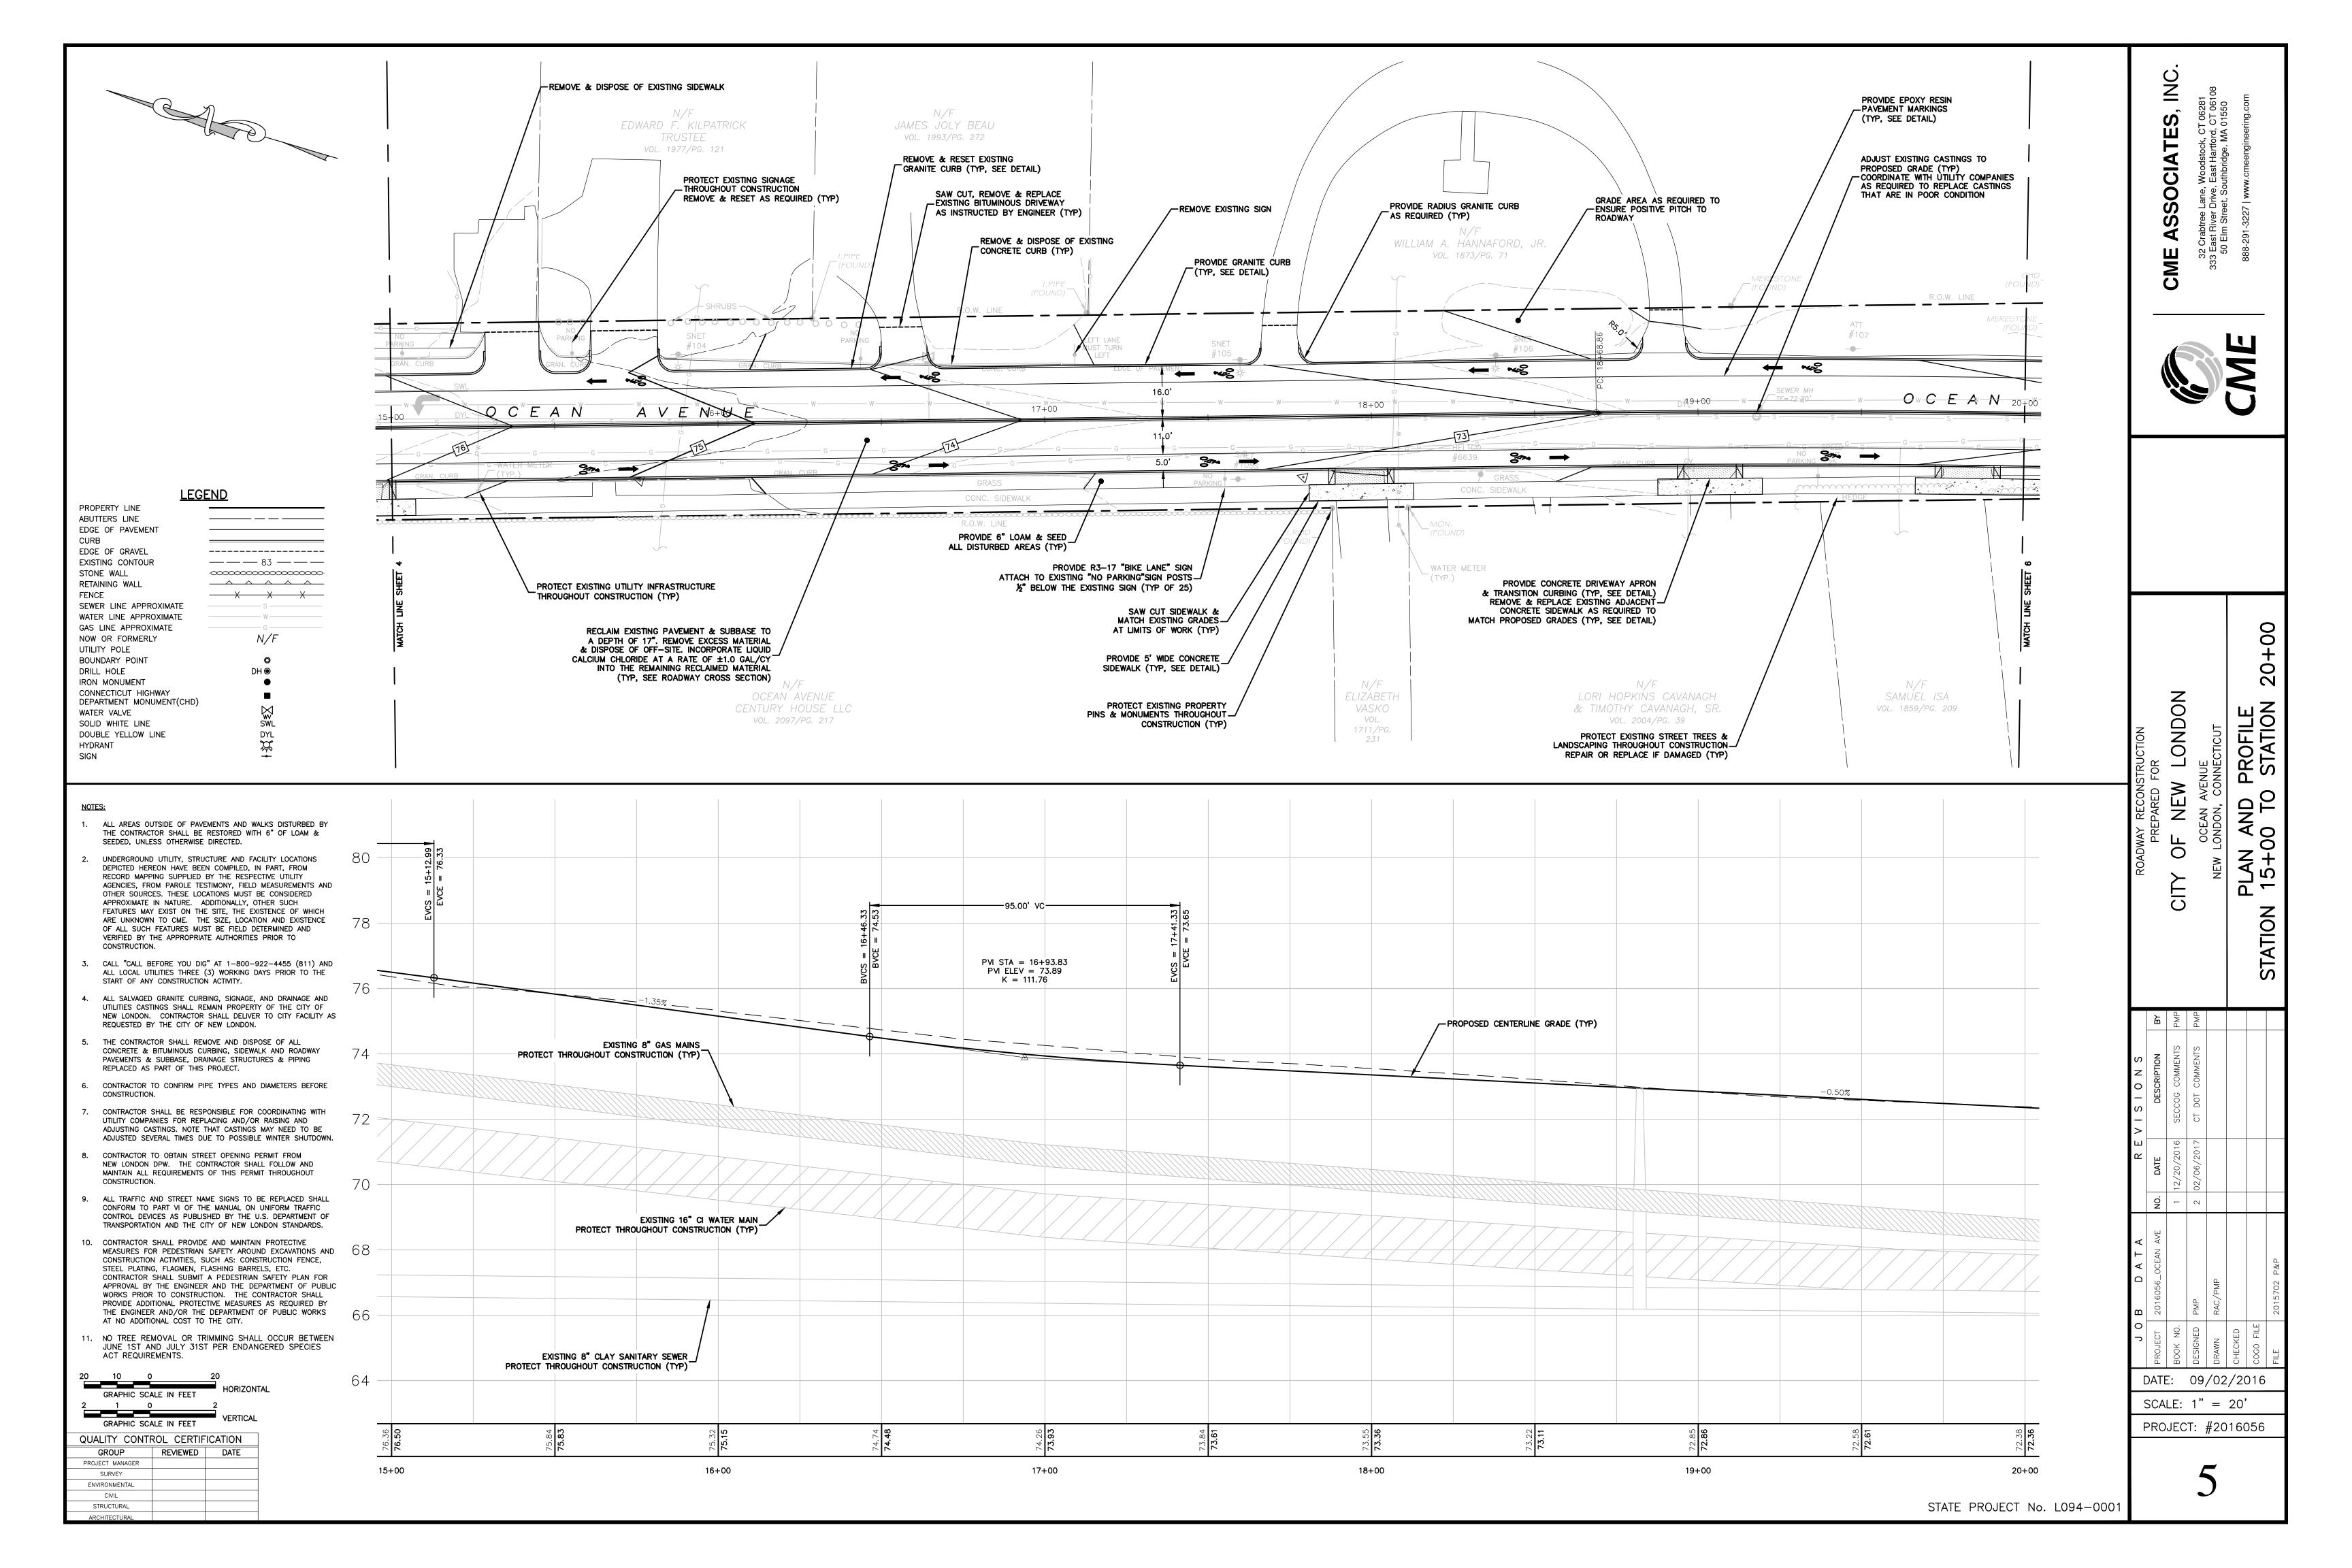


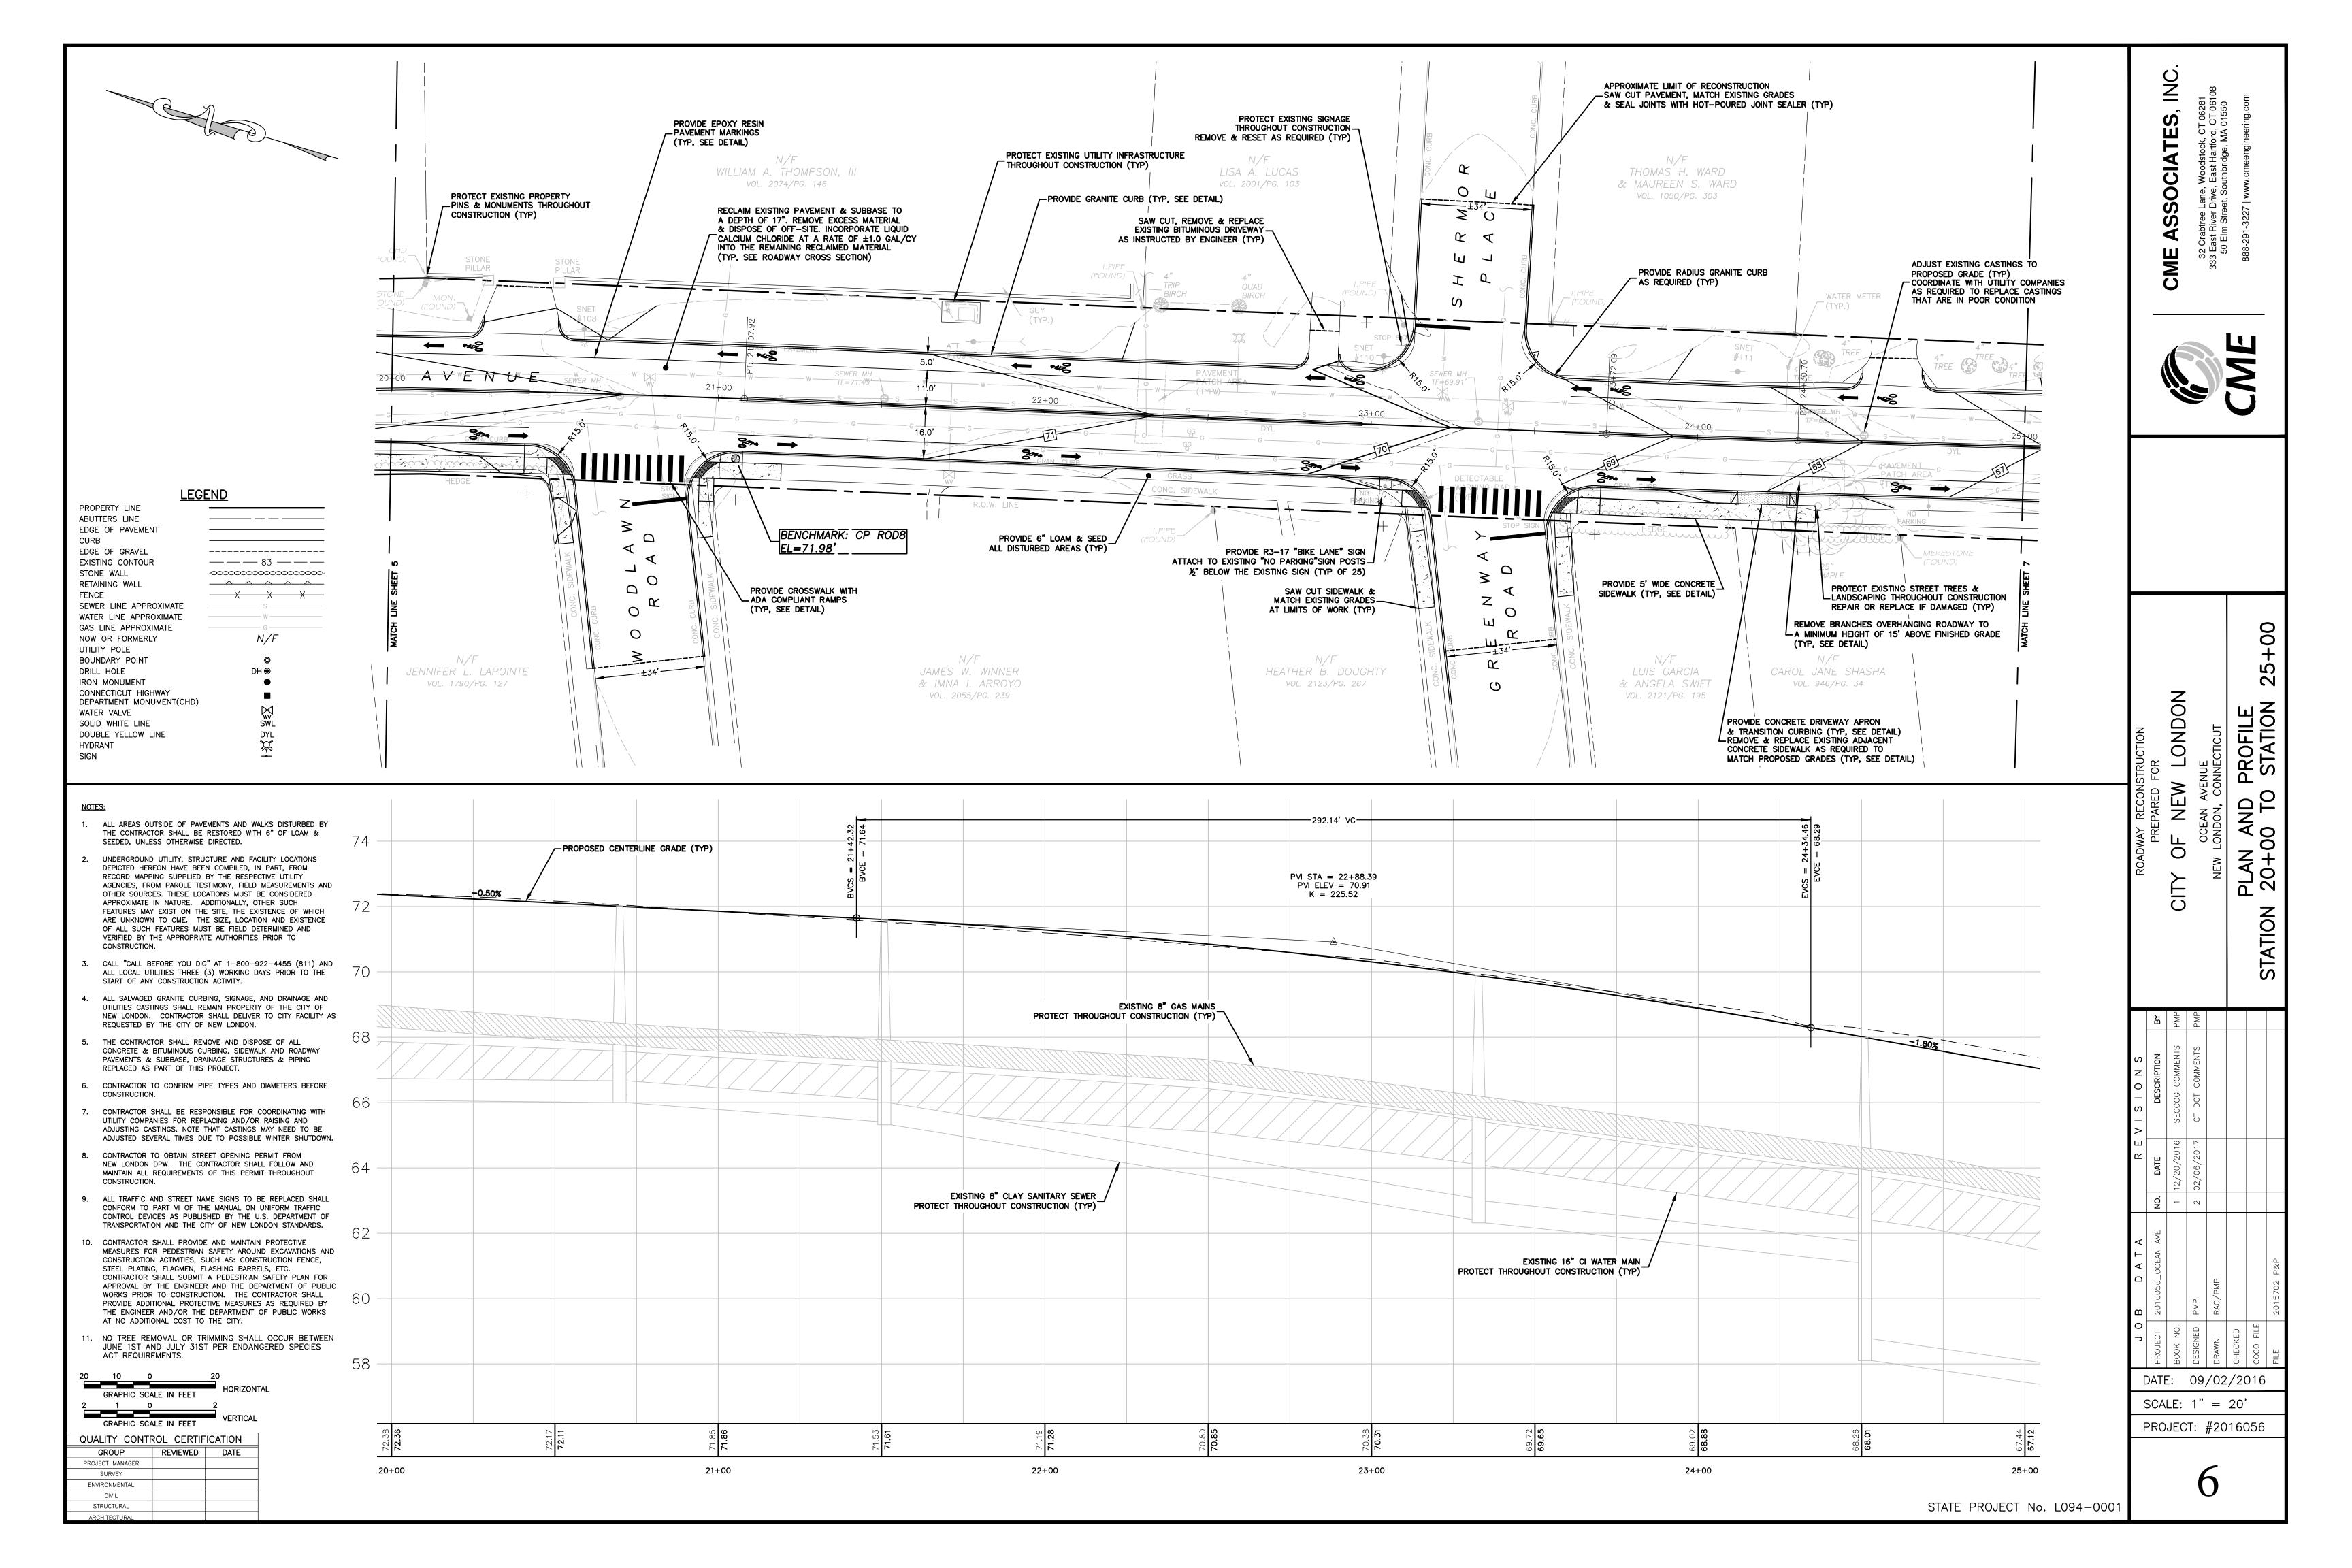


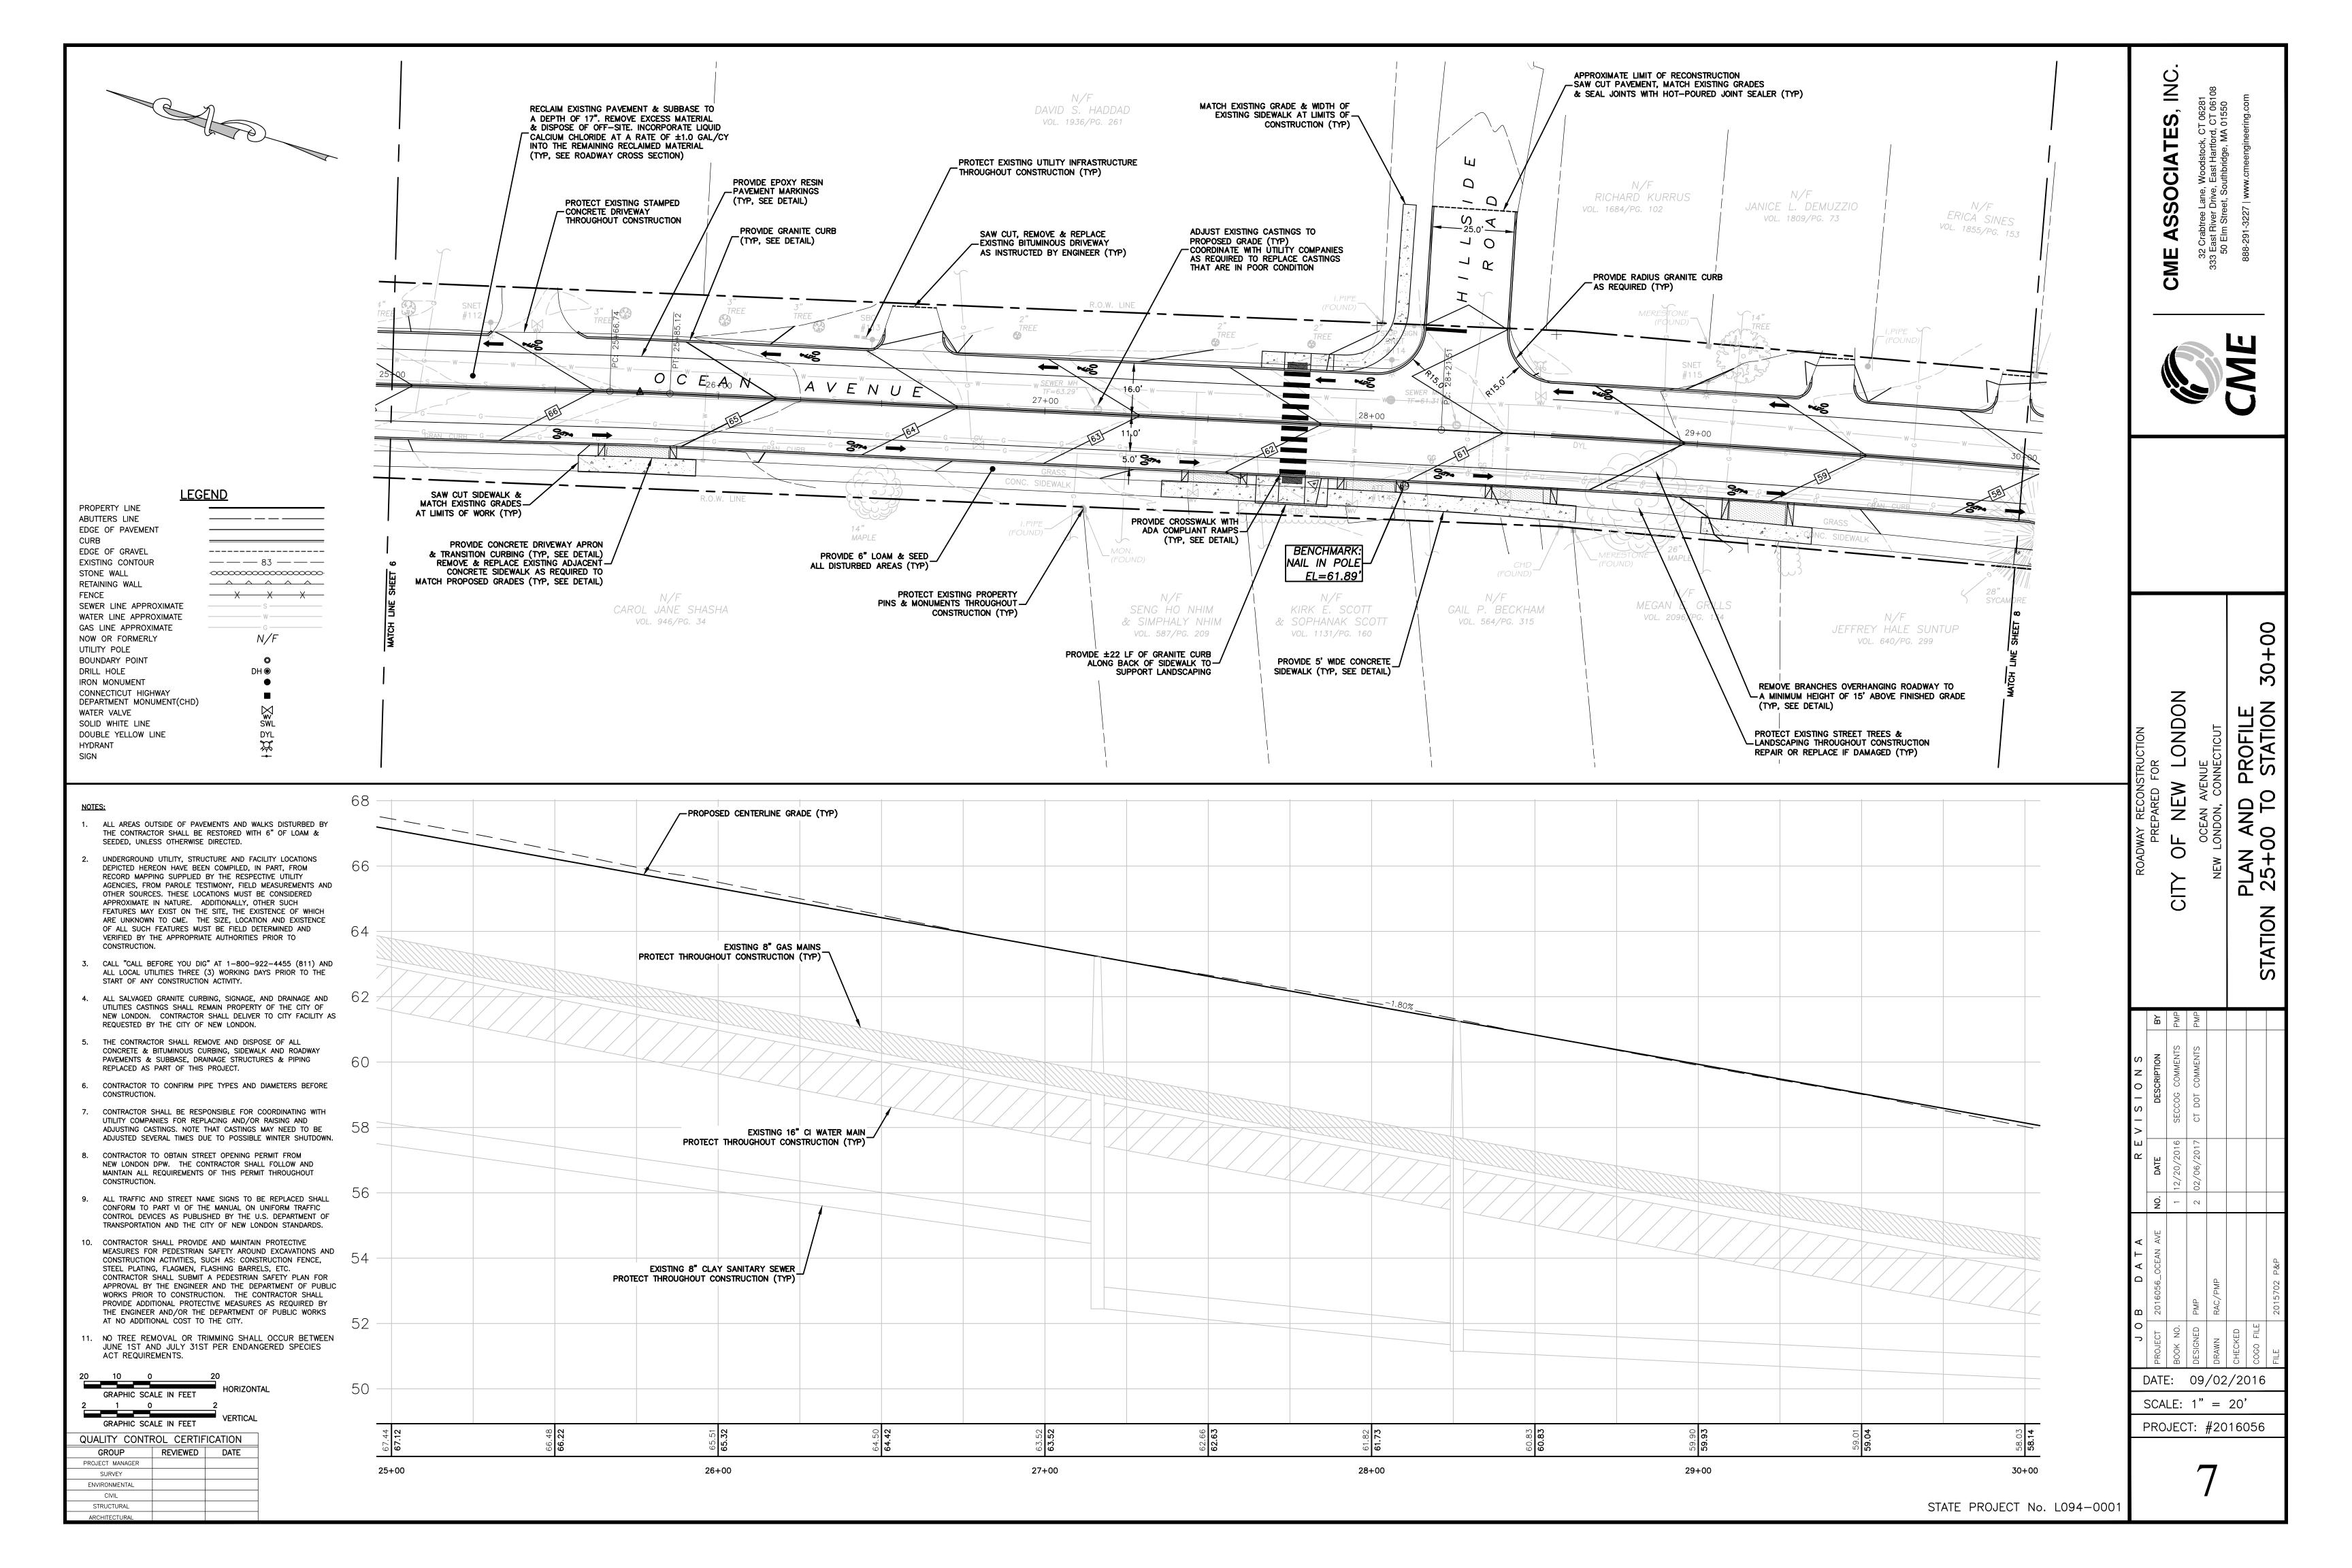


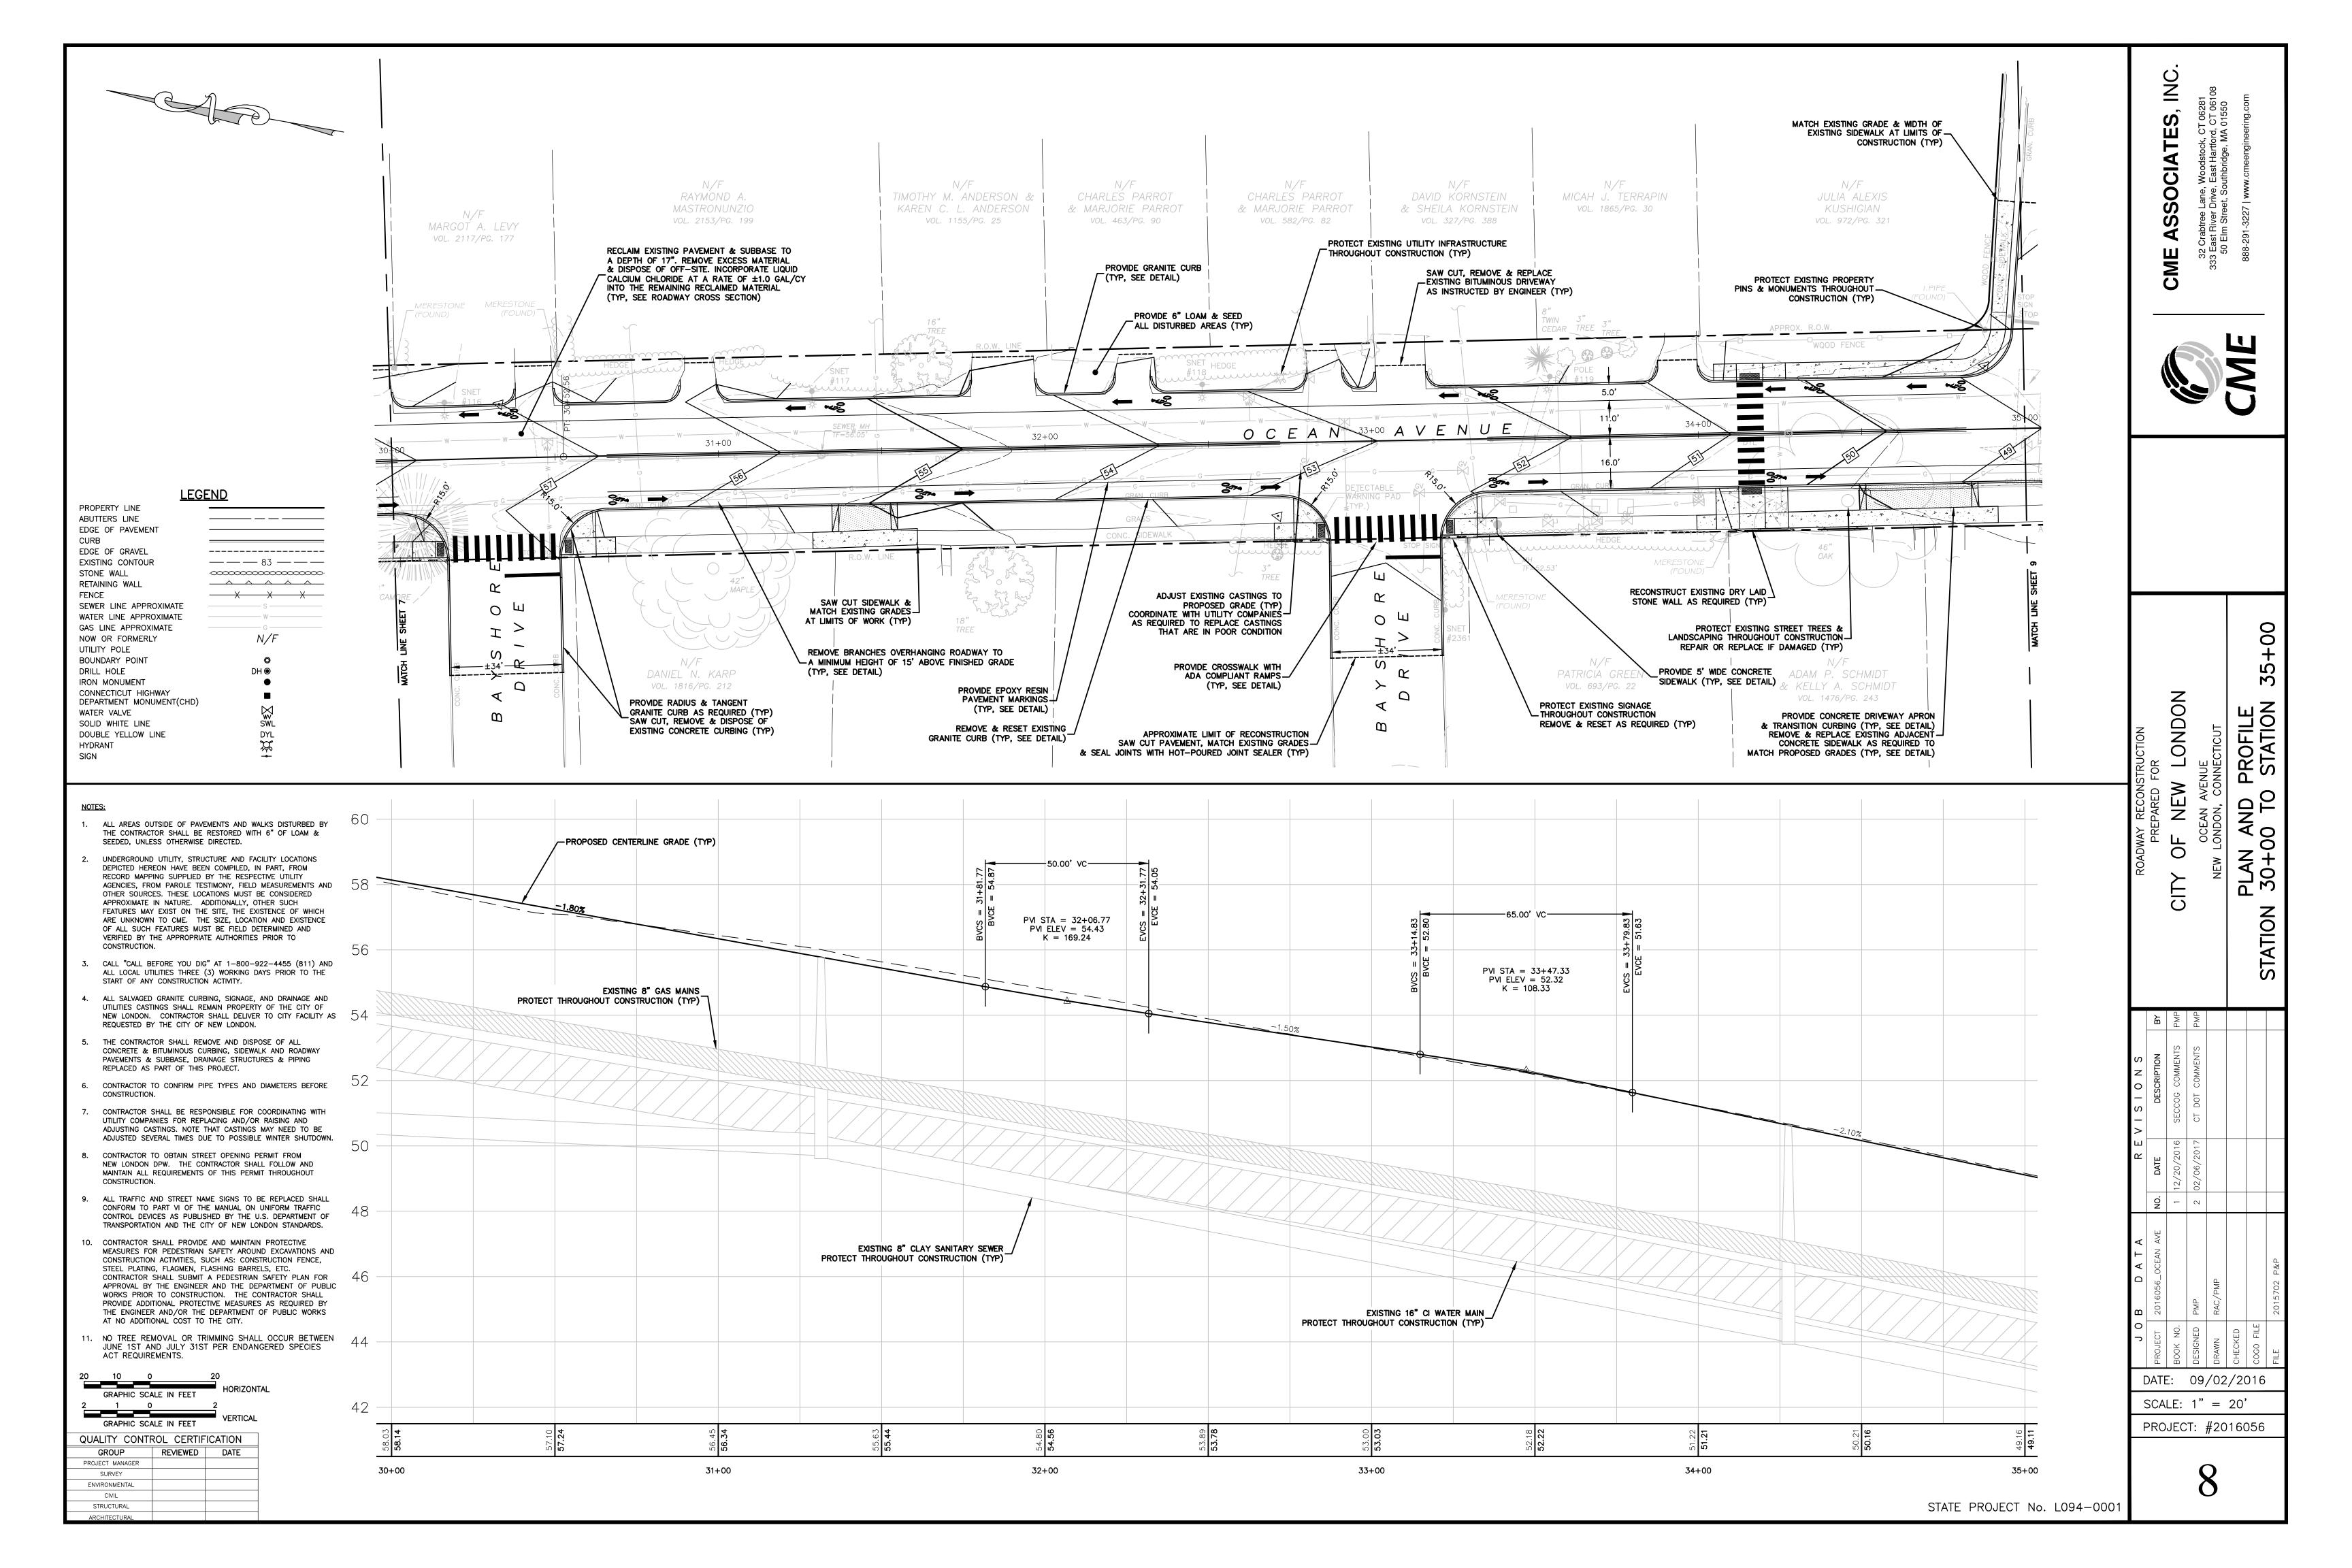


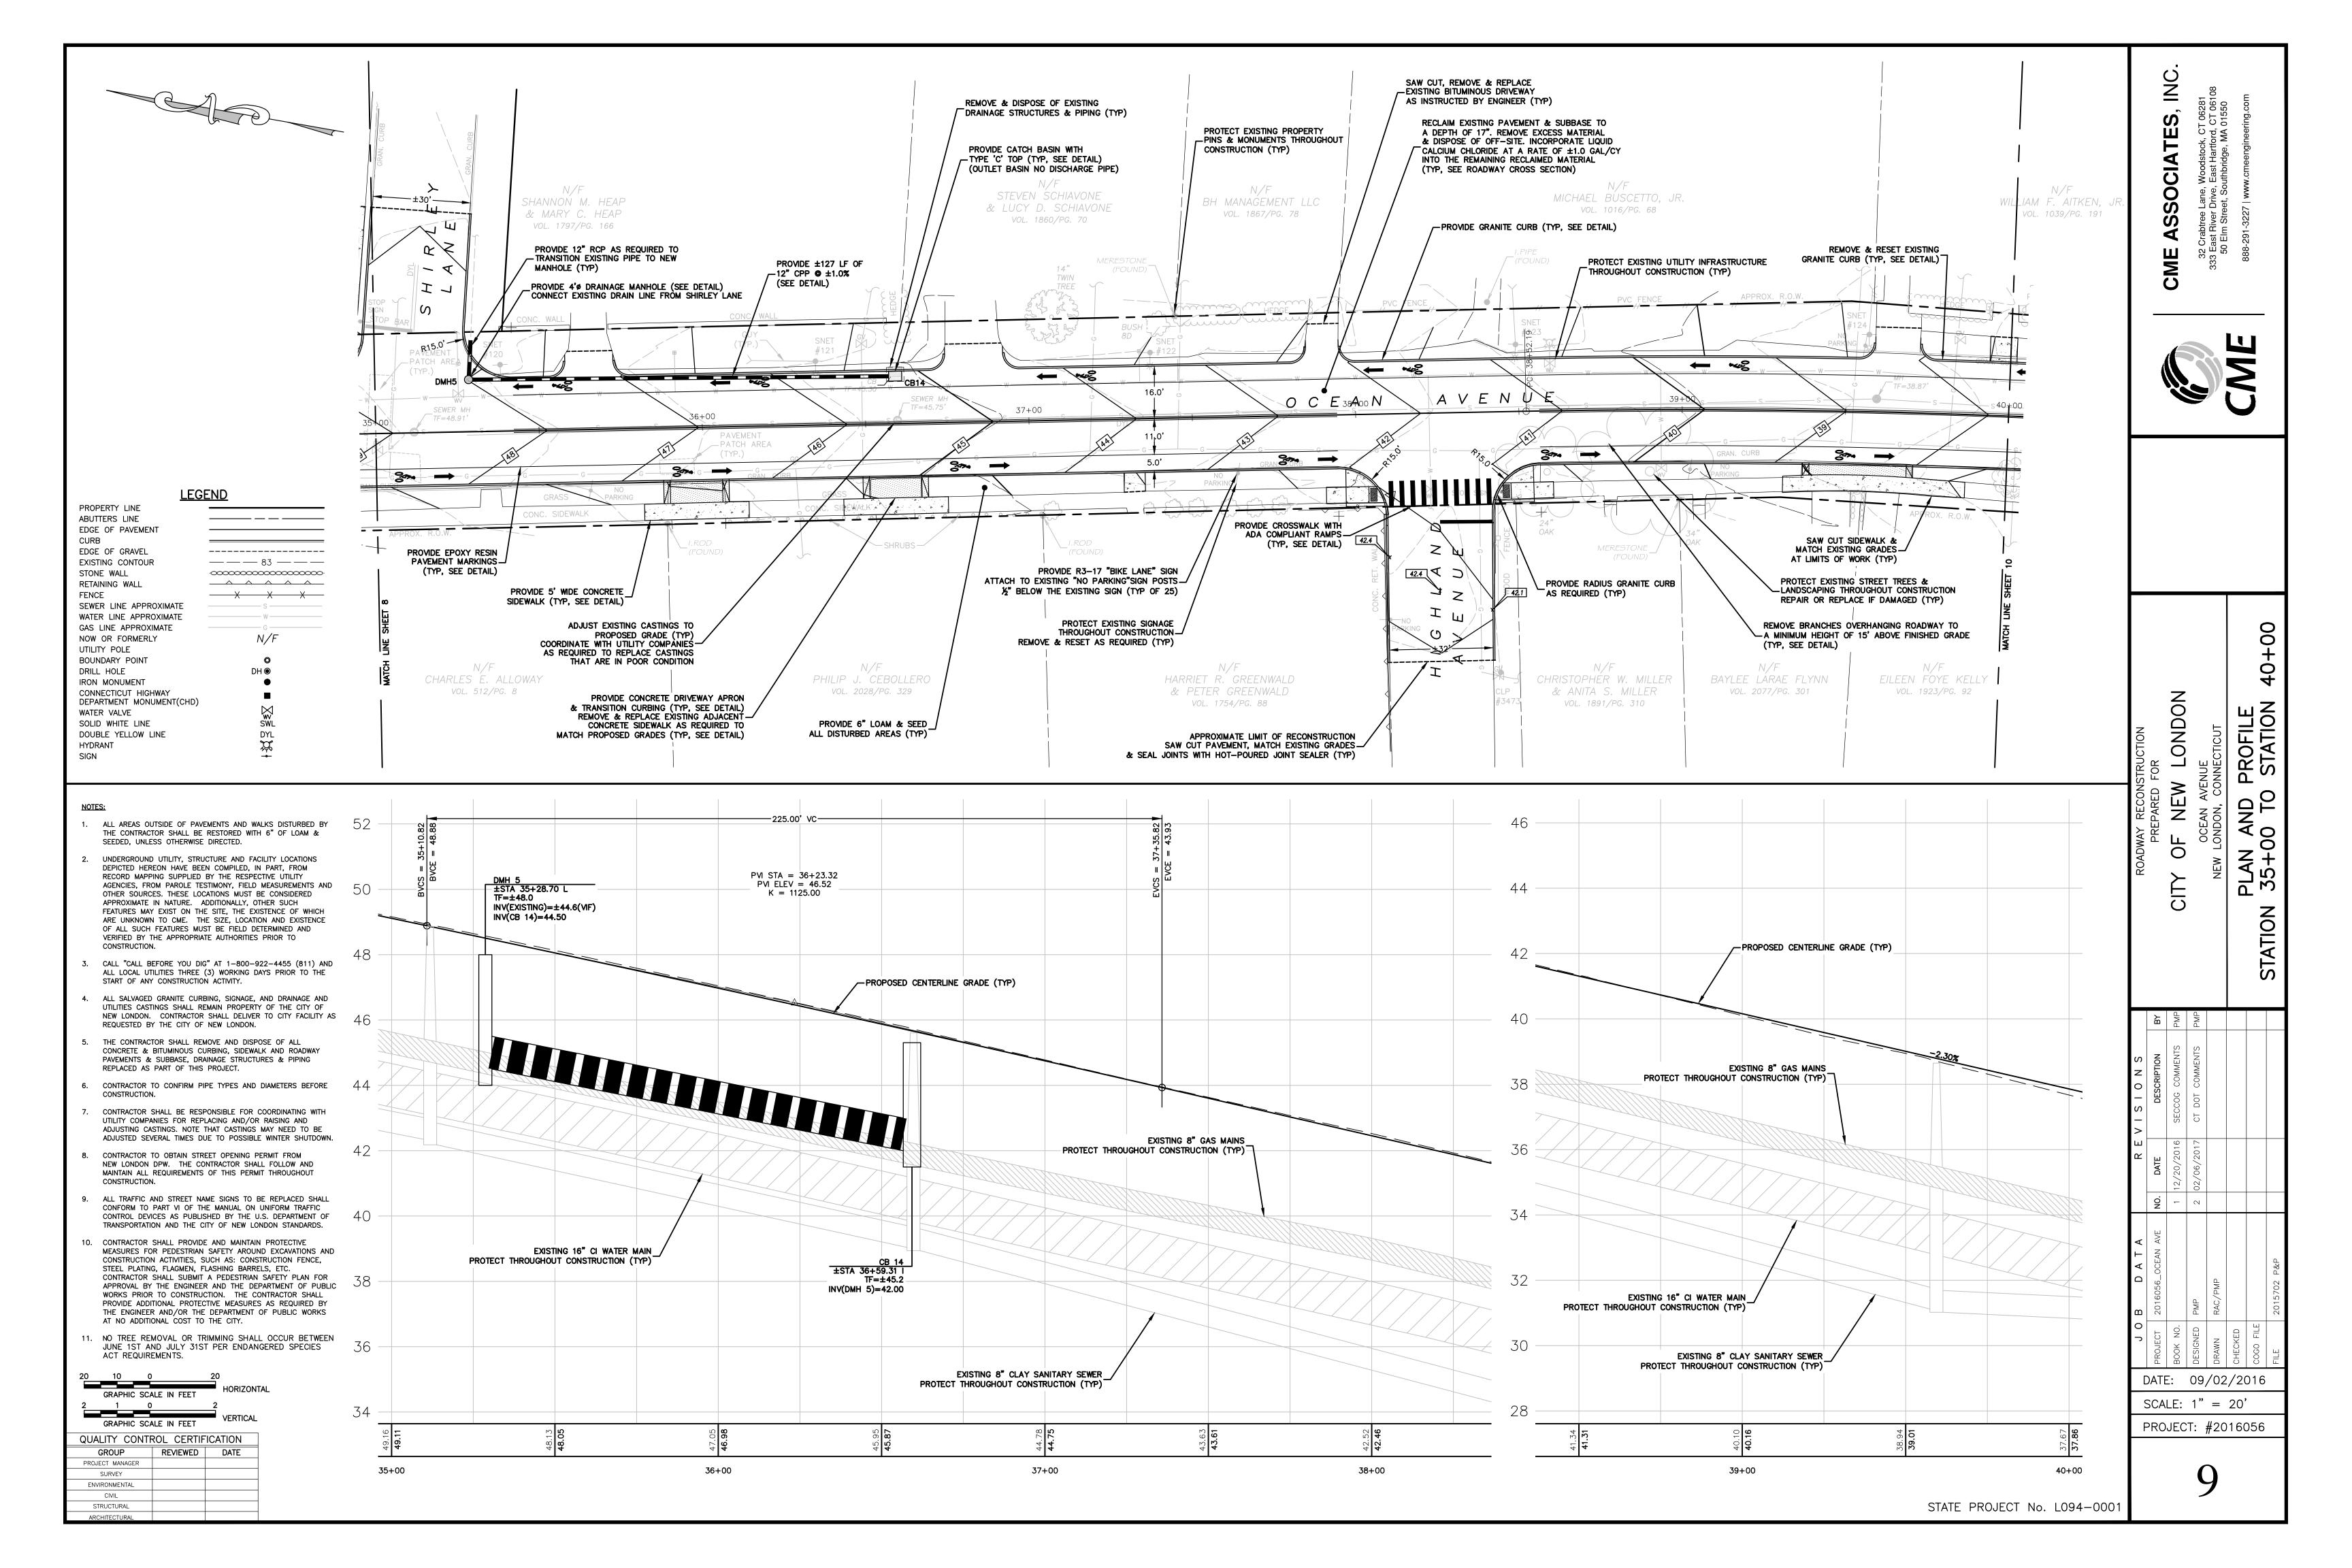

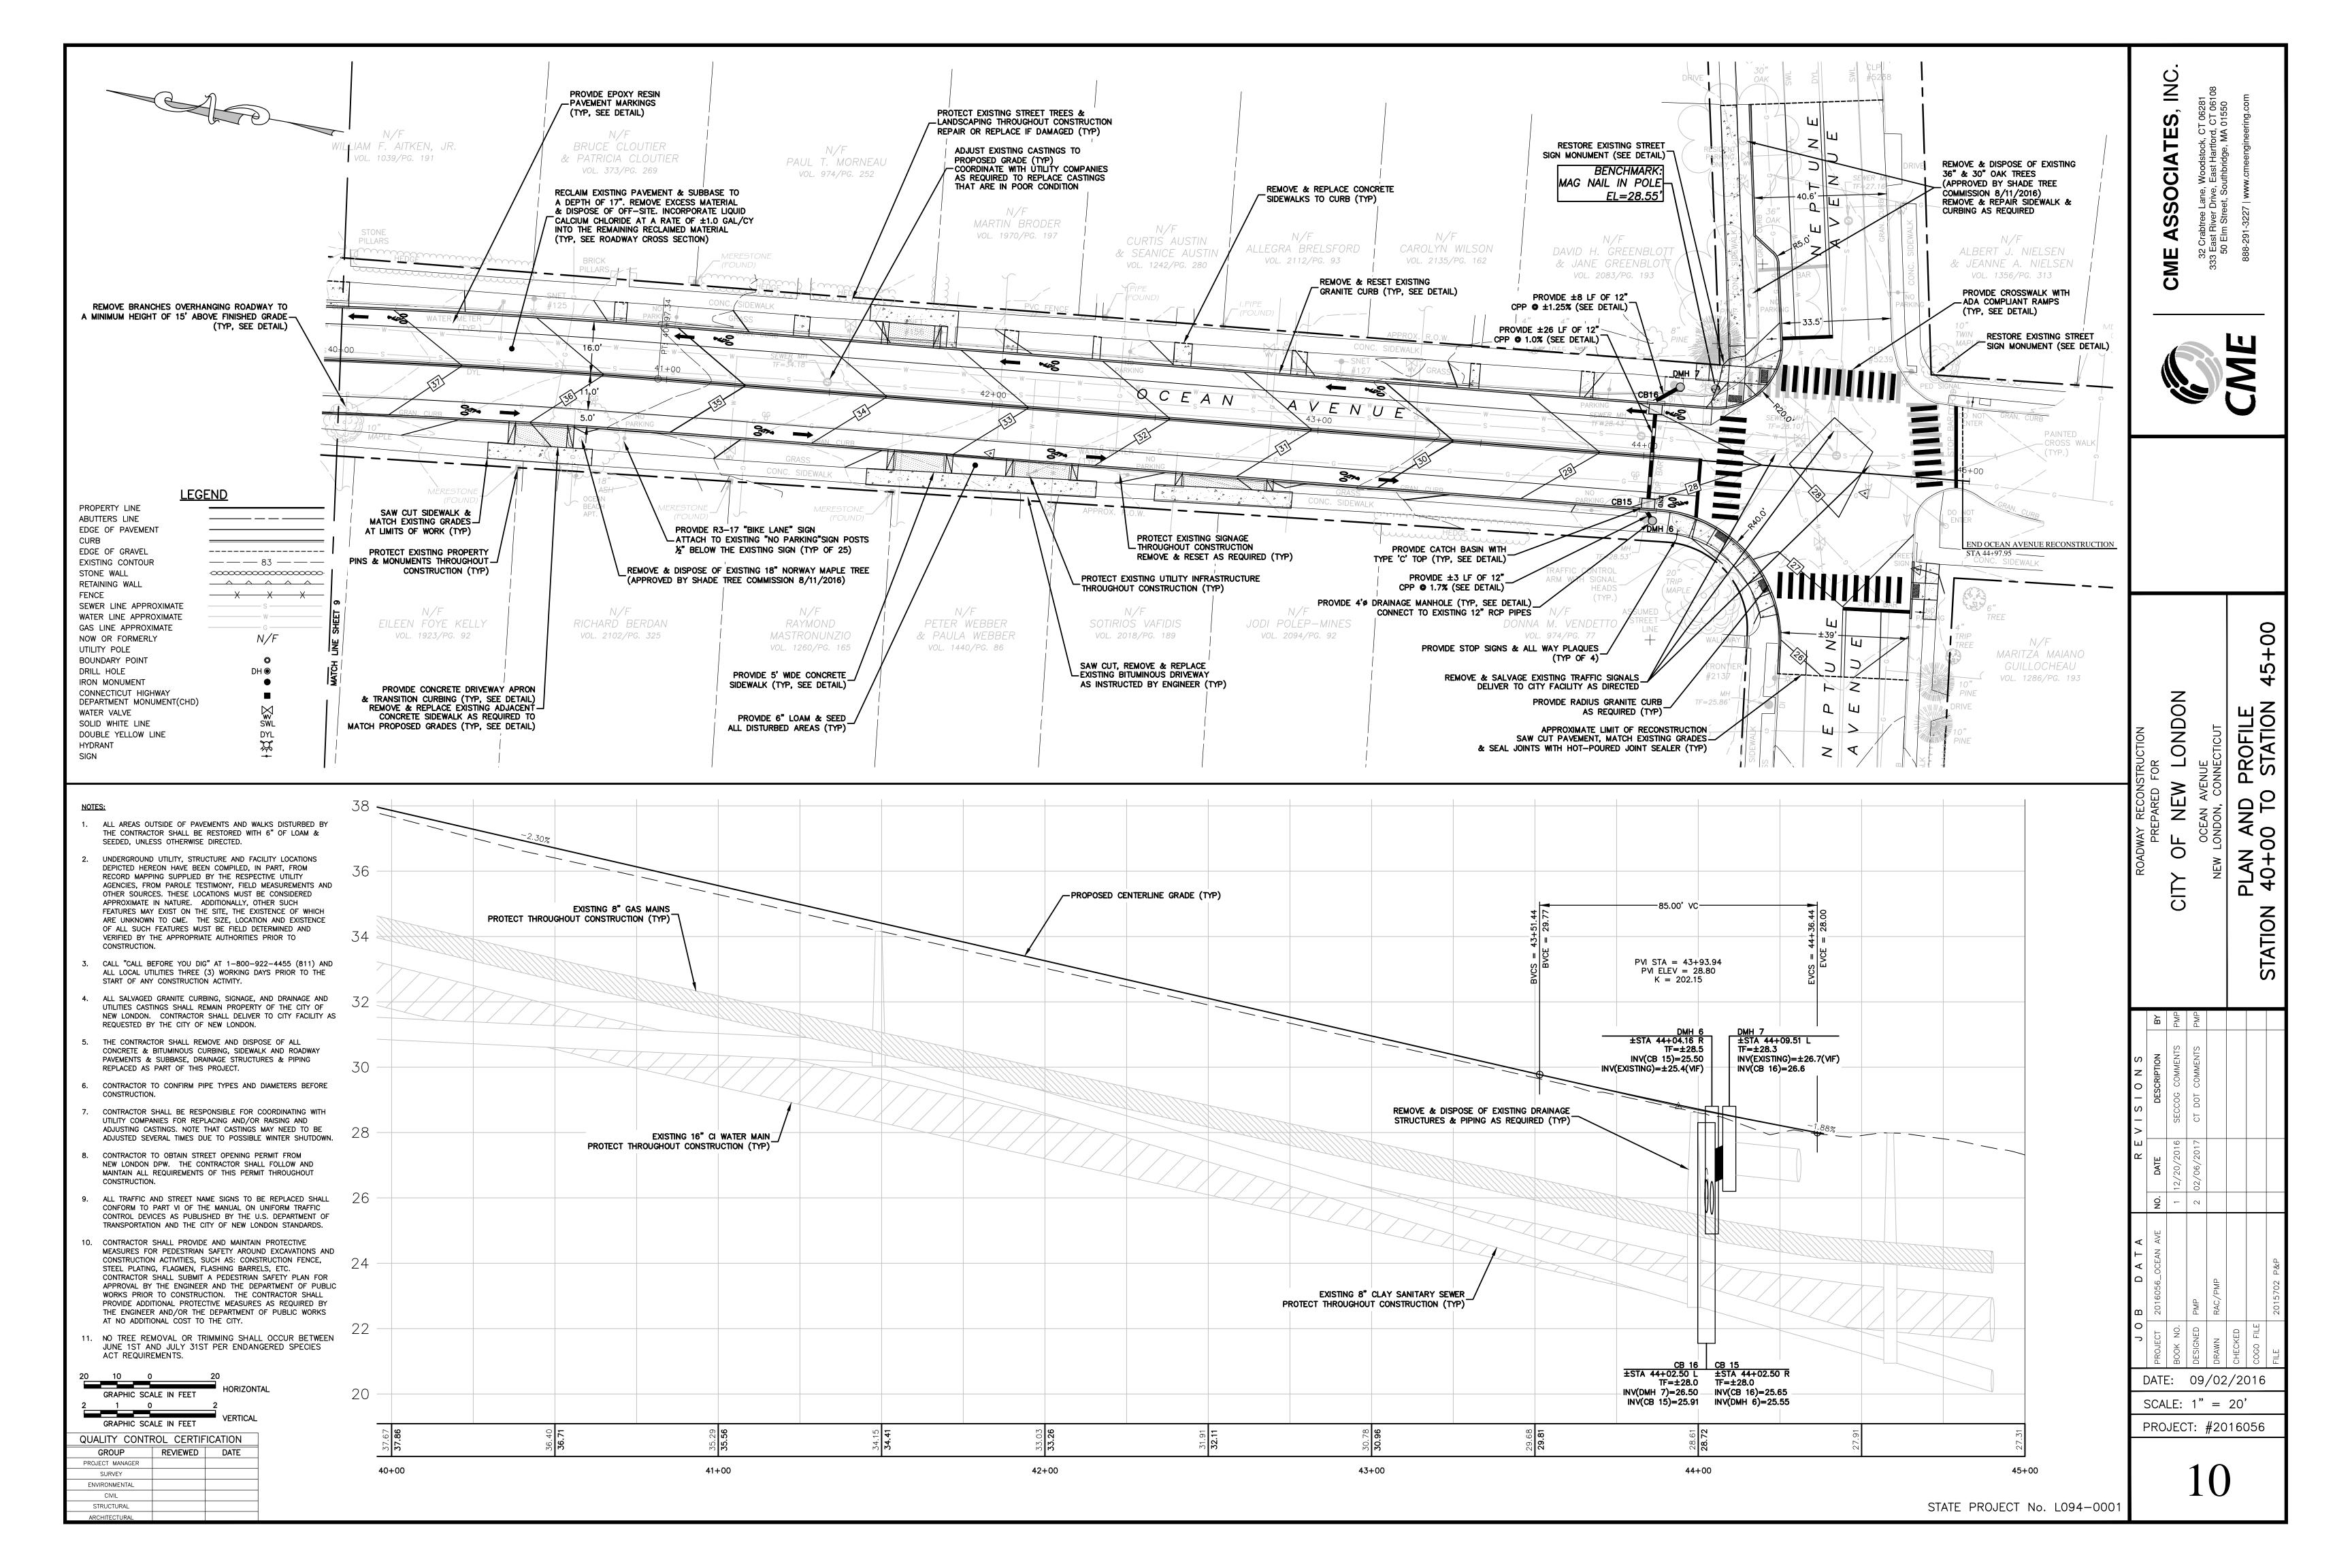

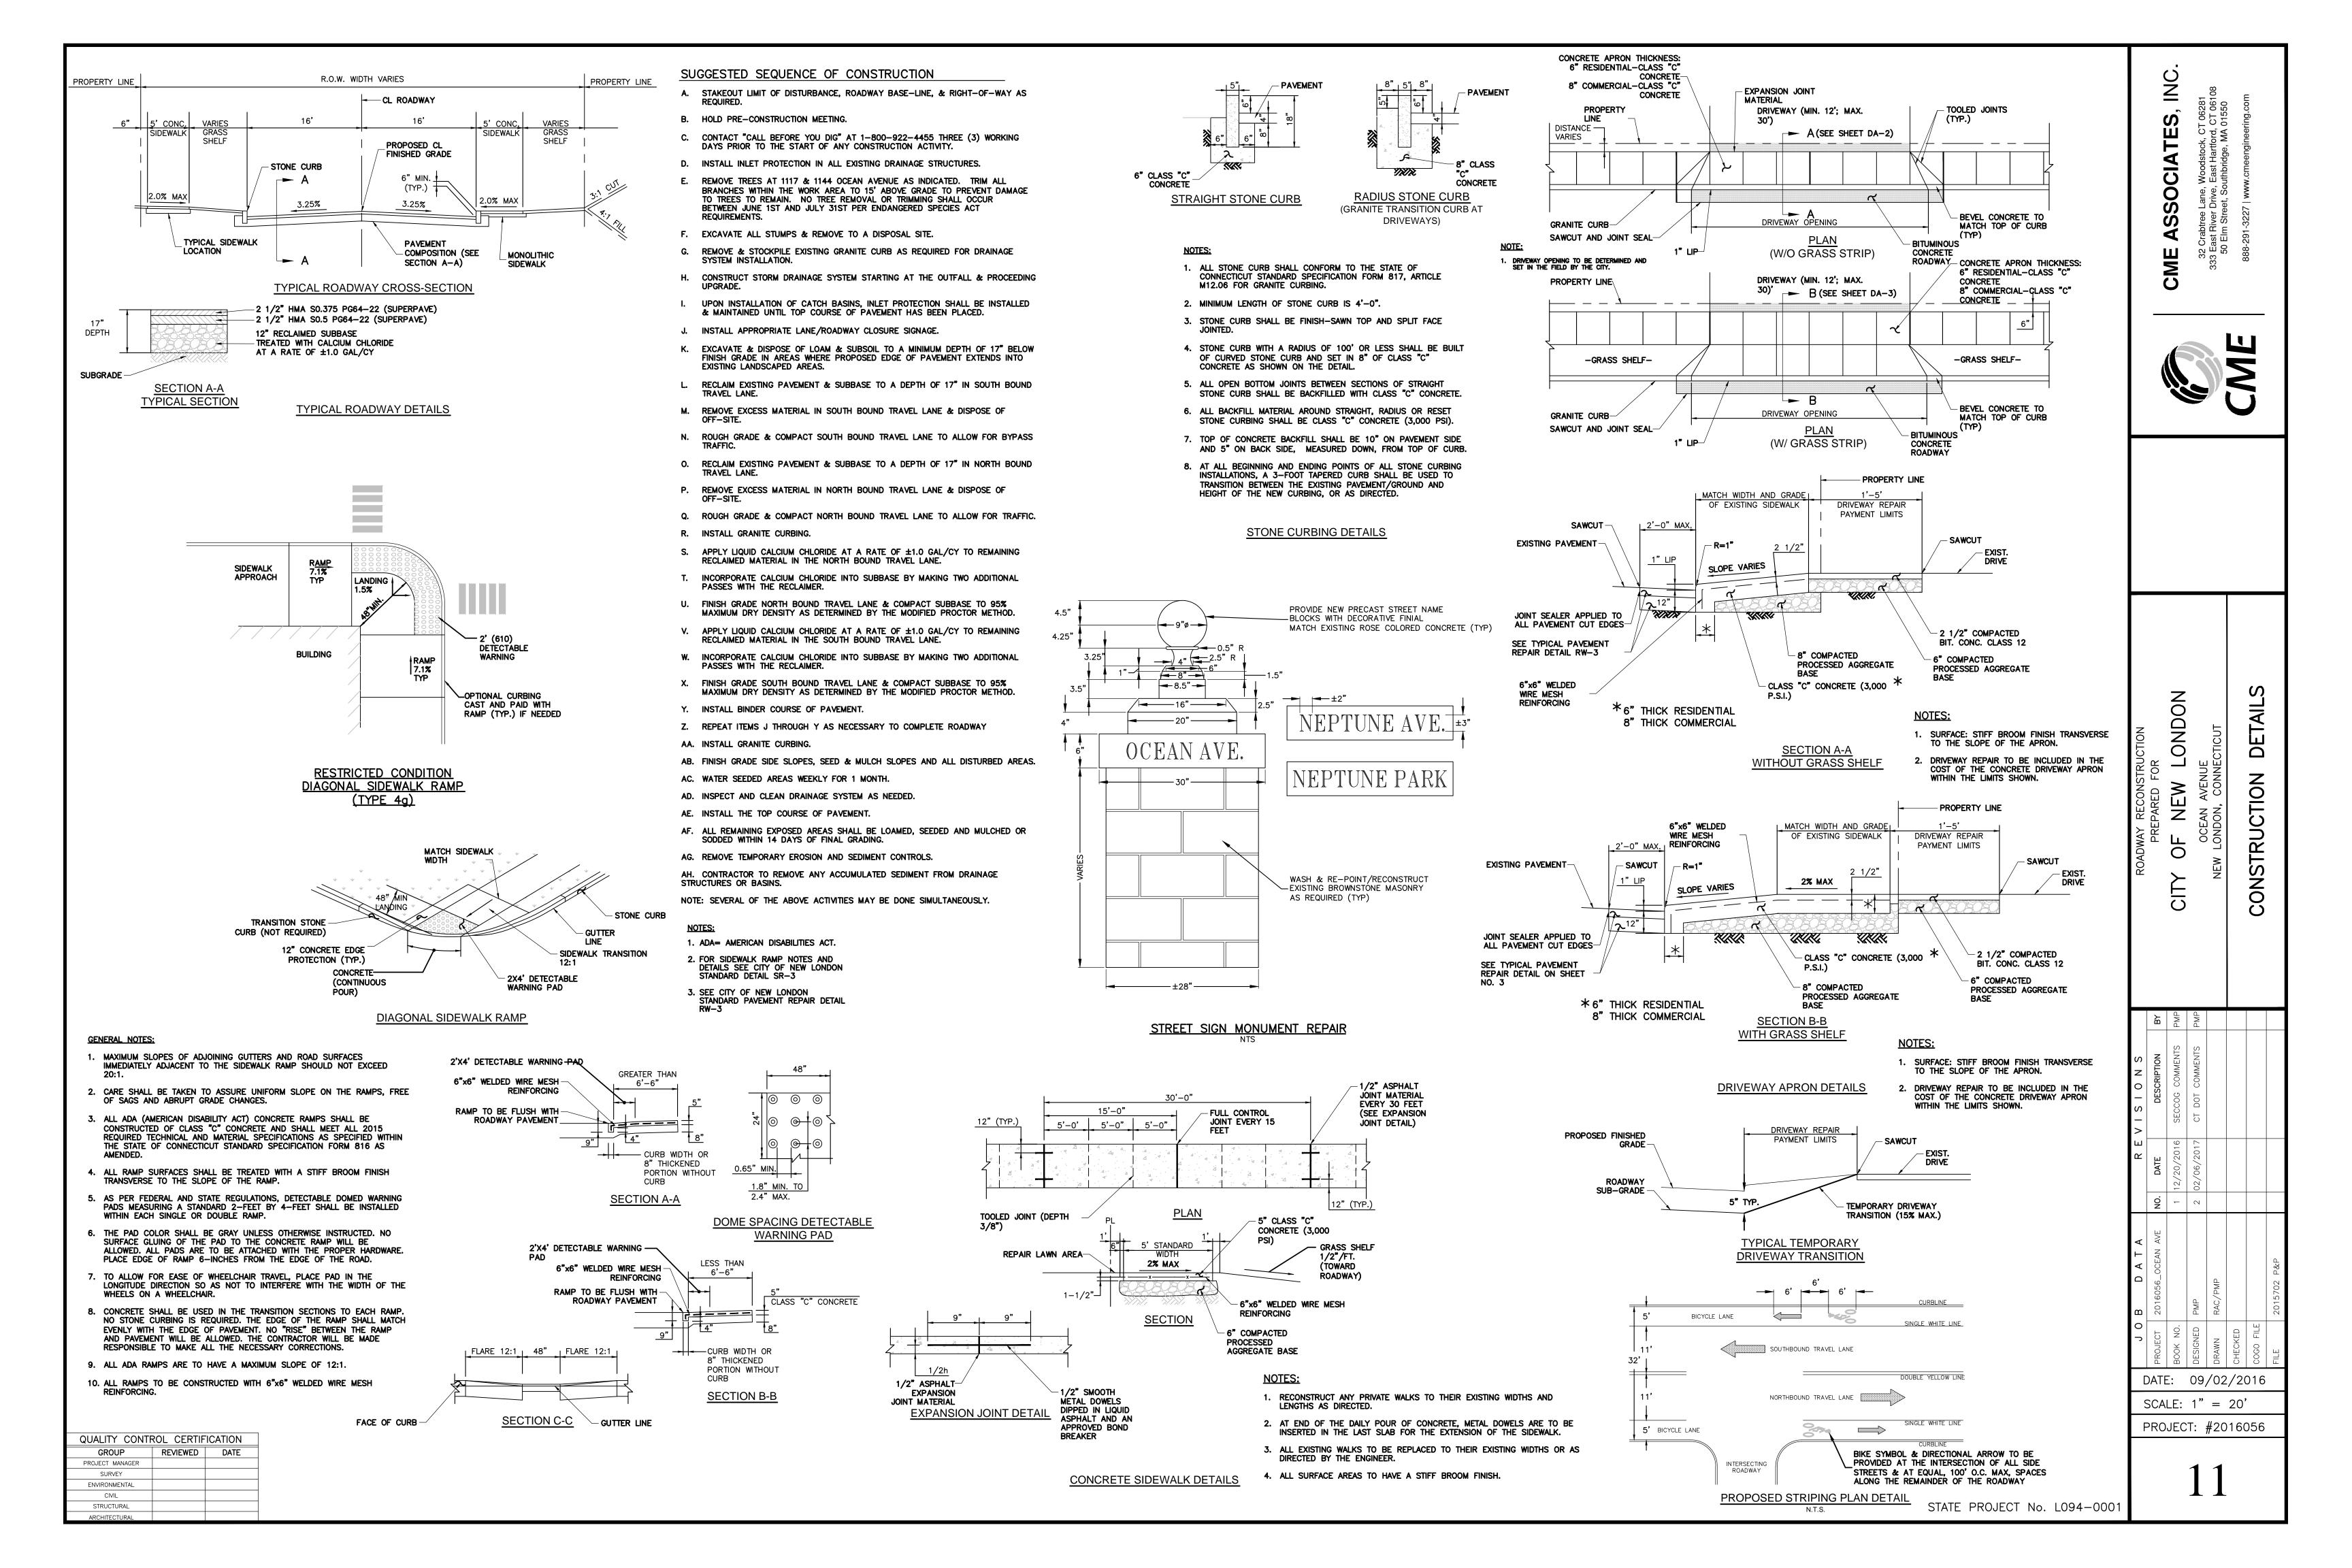

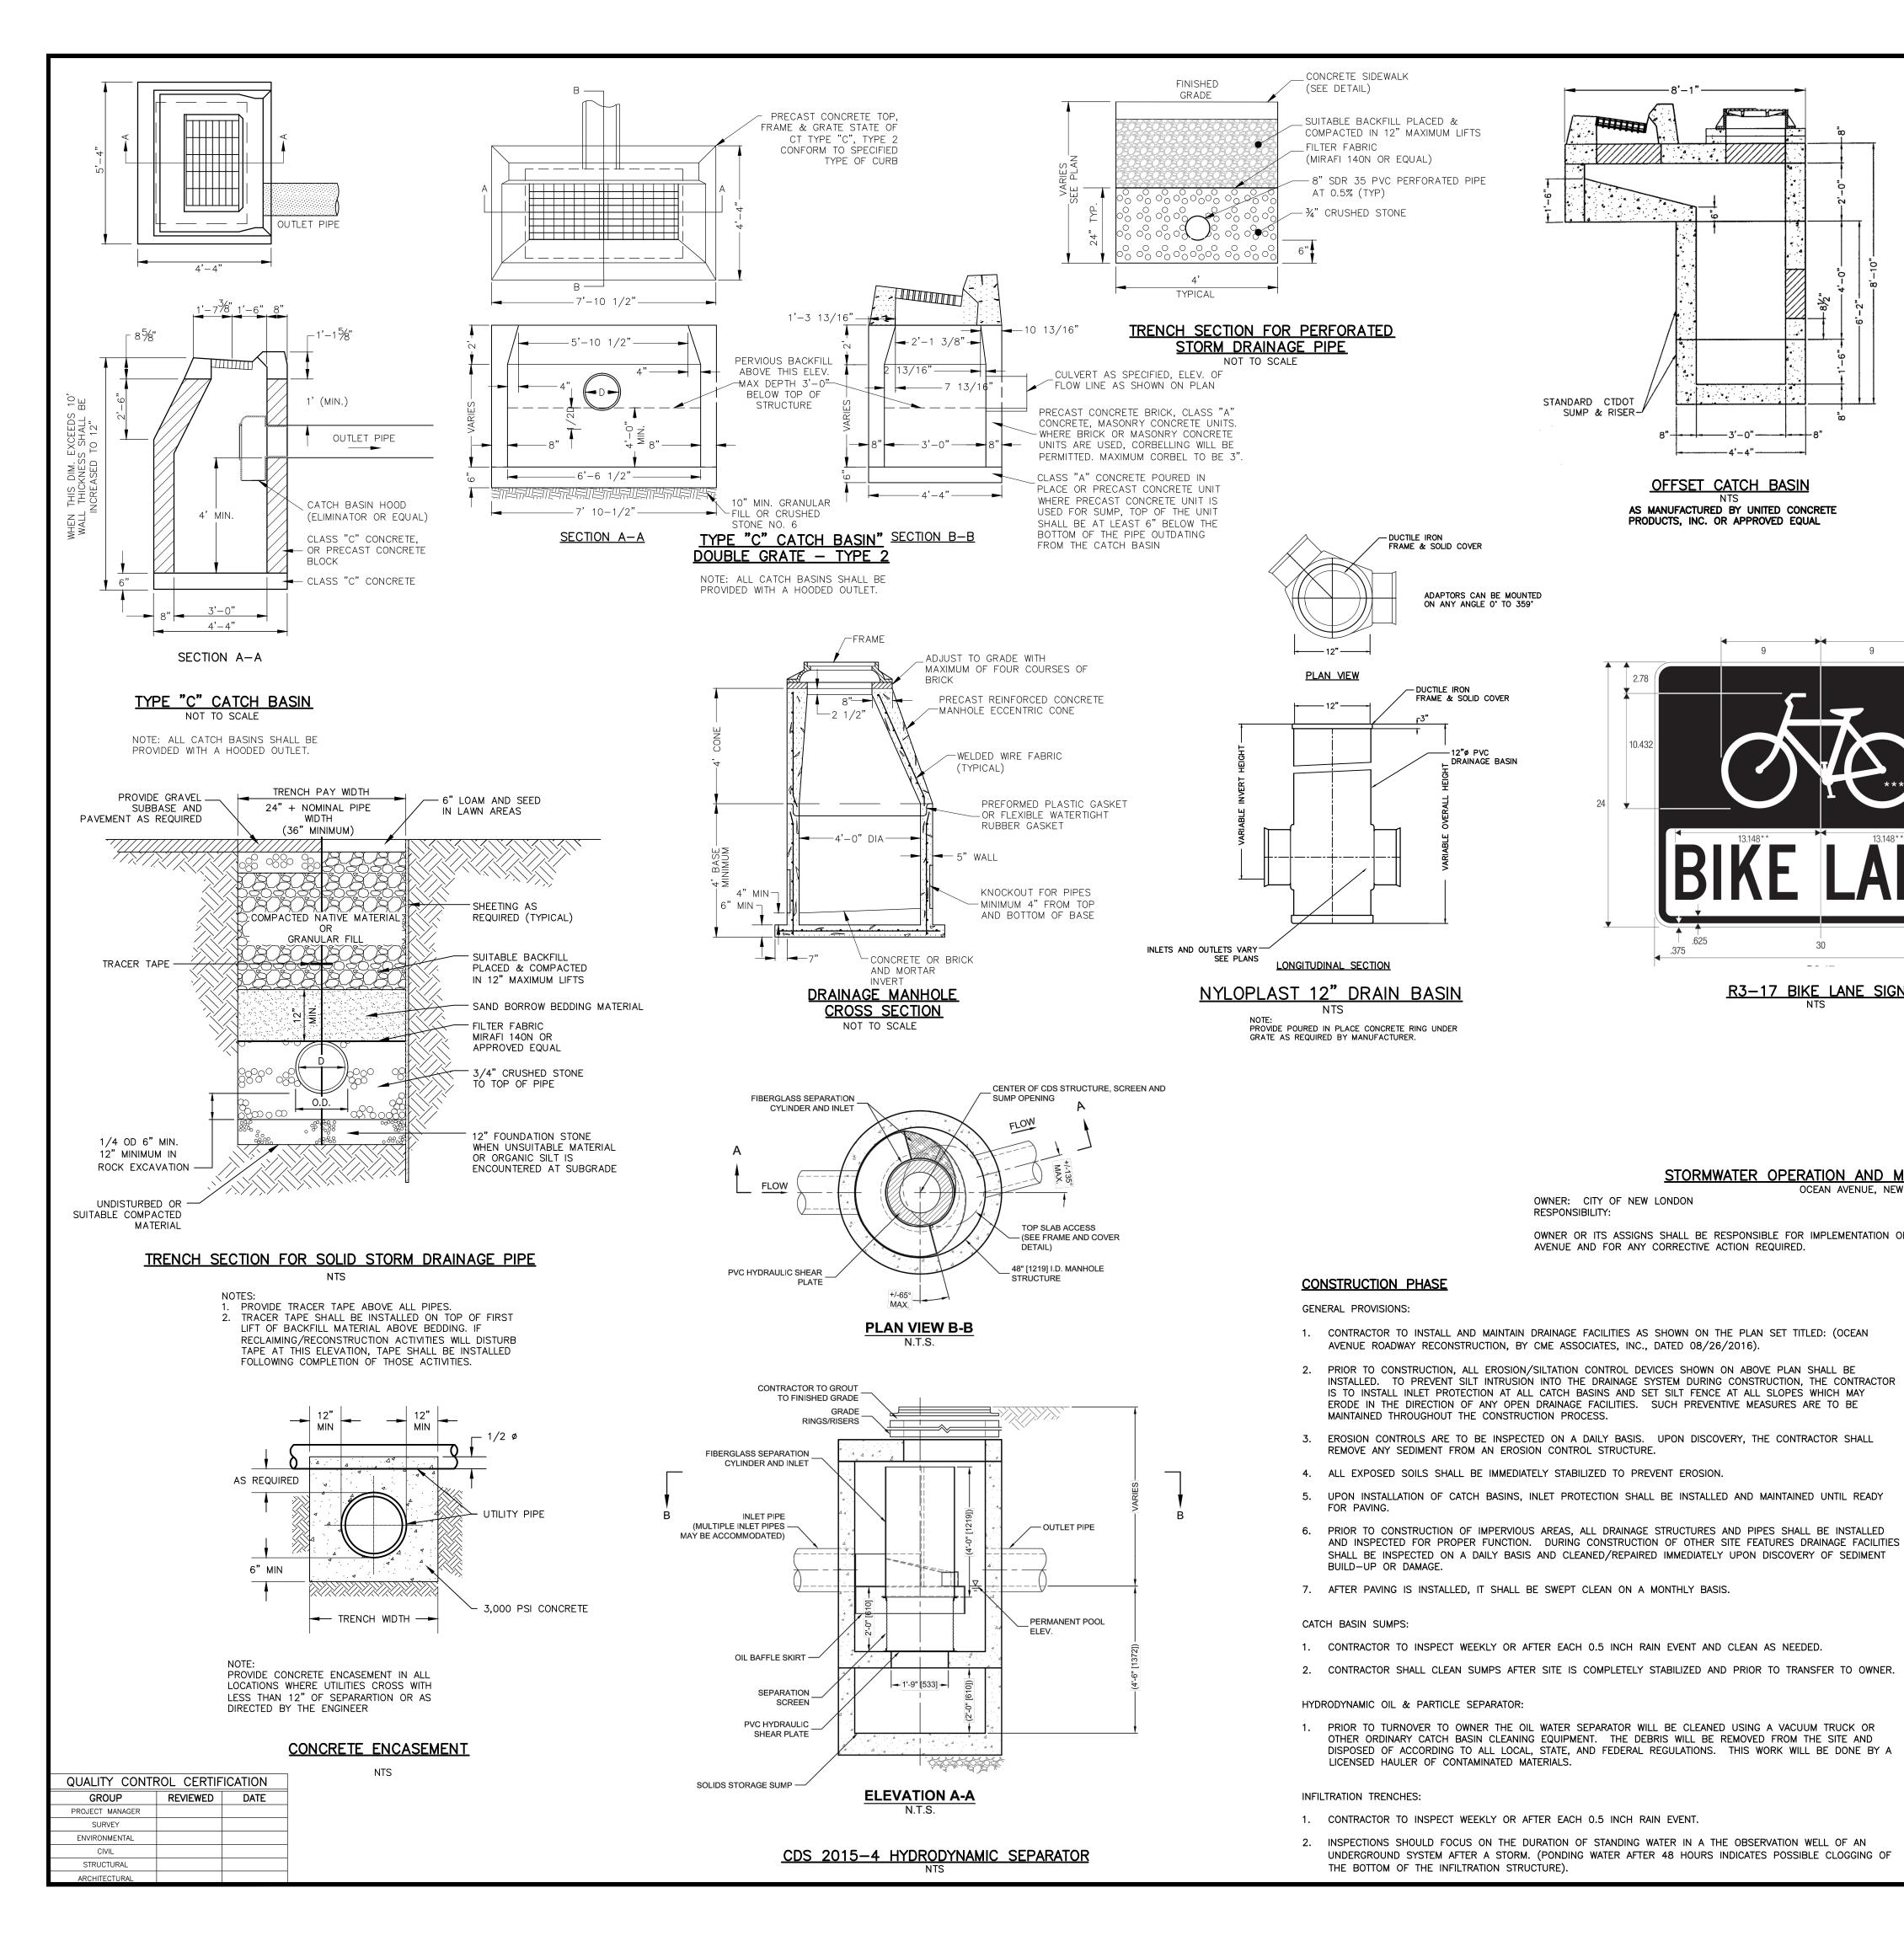

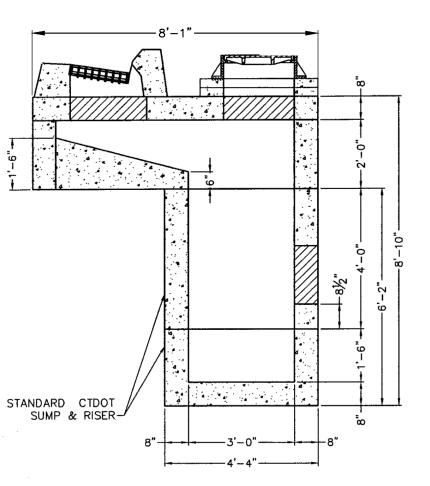

OFFSET CATCH BASIN AS MANUFACTURED BY UNITED CONCRETE PRODUCTS, INC. OR APPROVED EQUAL

FRAME & SOLID COVER

ADAPTORS CAN BE MOUNTED ON ANY ANGLE 0° TO 359°

OWNER: CITY OF NEW LONDON

AVENUE AND FOR ANY CORRECTIVE ACTION REQUIRED.

RESPONSIBILITY:

- DUCTILE IRON FRAME & SOLID COVER




STORMWATER OPERATION AND MAINTENANCE AGREEMENT OCEAN AVENUE, NEW LONDON

First, cut part way through the branch at A; then cut it off at B. Make the final cut at C.

Branch collar


TREE PRUNING DETAIL

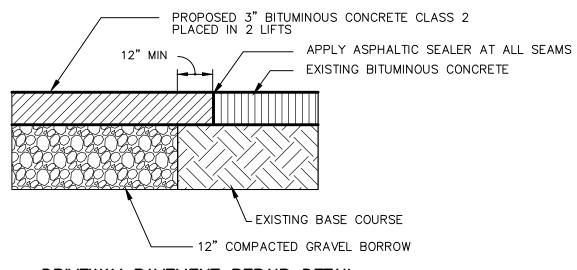

DRIVEWAY PAVEMENT REPAIR DETAIL

1. ALL PAVEMENT SHALL CONFORM TO PAVEMENT SPECIFICATION INCLUDED IN THE CONTRACT DOCUMENTS.

2. ALL SEAMS SHALL BE SAWCUT AND STRAIGHT

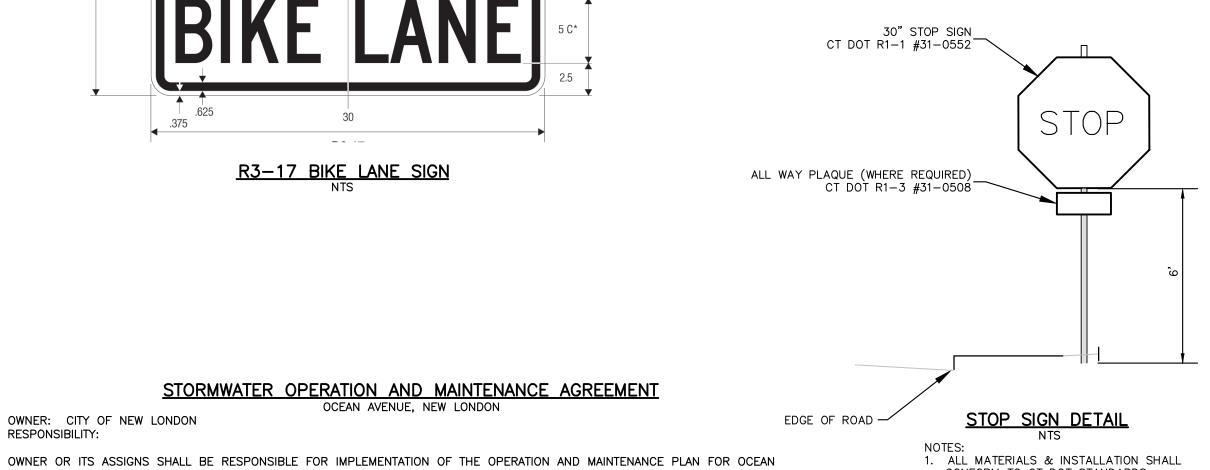

1. ALL MATERIALS & INSTALLATION SHALL CONFORM TO CT DOT STANDARDS. 2. EDGE OF SIGN SHALL BE A MINIMUM OF 2' &

A MAXIMUM OF 8' FROM FACE OF CURB.

PAVEMENT SWEEPING:

STREETS AND PARKING LOTS SHOULD BE SWEPT CLEAN AT LEAST ONCE ANNUALLY, PREFERABLY IMMEDIATELY AFTER WINTER SNOW MELT AND BEFORE SPRING RAINS. SWEEPING DURING THIS PERIOD CAPTURES PEAK SEDIMENT LOADS AND EXTENDS THE SERVICE LIFE OF THE STORM WATER MANAGEMENT

CATCH BASIN SUMPS:

POST-DEVELOPMENT PHASE

CATCH BASINS SHALL BE INSPECTED BI-ANNUALLY AND CLEANED AT LEAST ANNUALLY, AFTER THE SNOW AND ICE SEASON, AND AS SOON AS POSSIBLE BEFORE SPRING RAINS. IN GENERAL, A CATCH BASIN SHOULD BE CLEANED IF THE DEPTH OF DEPOSITS IS GREATER THAN ONE HALF THE SUMP DEPTH. IF A CATCH BASIN SIGNIFICANTLY EXCEEDS THIS STANDARD THEN MORE FREQUENT CLEANINGS SHALL BE SCHEDULED. IN AREAS WITH HIGHER POLLUTANT LOADINGS OR DISCHARGES INTO SENSITIVE BODIES OF WATER, MORE FREQUENT CLEANINGS WILL BE NECESSARY.

HYDRODYNAMIC OIL & PARTICLE SEPARATOR:

THE OIL WATER SEPARATOR WILL BE INSPECTED QUARTERLY FOR THE PRESENCE OF ACCUMULATED OIL AND GREASE, FLOATABLES AND SEDIMENT, IF FOUND, THE STRUCTURE WILL BE CLEANED USING A VACUUM TRUCK OR OTHER ORDINARY CATCH BASIN CLEANING EQUIPMENT. THE DEBRIS WILL BE REMOVED FROM THE SITE AND DISPOSED OF ACCORDING TO ALL LOCAL, STATE, AND FEDERAL REGULATIONS. THIS WORK WILL BE DONE BY A LICENSED HAULER OF CONTAMINATED MATERIALS. THE SCHEDULE OF INSPECTIONS WILL BE ADJUSTED TO AN ANNUAL INSPECTION IF NO OIL OR GREASE IS FOUND ON A REGULAR BASIS. OWNER WILL BE RESPONSIBLE FOR THE INSPECTIONS AND CLEANING.

INFILTRATION TRENCHES:

INFILTRATION SYSTEMS SHALL BE INSPECTED AT LEAST TWICE ANNUALLY AND AFTER ALL MAJOR STORMS TO ENSURE THAT THEY ARE OPERATING AS INTENDED. PRETREATMENT BMP'S SHALL BE INSPECTED AND CLEANED DURING THE REGULAR BI-ANNUAL INSPECTIONS. POTENTIAL PROBLEMS THAT SHOULD BE CHECKED

A. PONDING

B. EROSION C. CLOGGING OF INLET PIPES

STATE PROJECT No. L094-0001

<u></u>

CM

 \mathbf{O}

TION

O

Branch collar

DATE: 09/02/2016 SCALE: 1" = 20'

PROJECT: #2016056